PROPOSED ALBURY CORE & CLUSTER WITH 7 DWELLINGS & COMMUNITY FACILITY

271 BERNHARDT STREET, EAST ALBURY NSW 2640



ARTIST IMPRESSION

SUBJECT SITE



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PROJECT ADDRESS 271 BERNHARDT STREET, EAST ALBURY NSW 2640 DESIGN & ARCHITECTURE PROJECT MANAGER HOUSING PLUS DARREN WOODING PH: TBC PH: TBC HYDRAULIC STRUCTURAL/CIVIL TRICEND ENGINEERING TRICEND ENGINEERING PH: 13 227 676 PH: 13 227 676

BASIX CONSULTANT MICHAEL KIHO PH: 0400 680 815 LANDSCAPE CONSULTANT

PH: TBC

PROPOSED ALBURY CORE & CLUSTER WITH 7 DWELLINGS & COMMUNITY FACILITY

DRAWING TITLE COVER PAGE

DRAWING INDEX

PROPERTY DESCRIPTION

271 BERNHARDT STREET, EAST ALBURY

LOT 1 / DP38393

SITE AREA - 3,916.15.m²

DWG No.	Drawing Name				
1	COVER PAGE				
2	SURVEY				
3	PROPOSED DEMOLITION PLAN				
4	PROPOSED SITE PLAN				
5	PROPOSED EARTHWORKS PLAN				
6	RETAINING WALL DETAILS				
7	RETAINING WALL DETAILS				
8	PROPOSED FLOOR PLAN				
9	PROPOSED ROOF PLAN AND DRIVEWAY SECTION				
10	PROPOSED AREA CALCULATION				
11	PROPOSED SITE ELEVATIONS				
12	PROPOSED SITE ELEVATION AND SECTIONS				
13	PROPOSED CORE BUILDING				
14	PROPOSED COMMUNAL BUILDING				
15	PROPOSED UNIT 1, BIN & STORAGE ROOM BUILDING				
16	PROPOSED UNIT 2, 3 AND 4 BUILDING				
17	PROPOSED UNIT 5, 6 AND 7 BUILDING				
18	PROPOSED BIN & STORAGE ROOM BUILDING				
19	LANDSCAPE PLAN				

DRAUGHT SEALING

EXTERNAL WALLS: R2.5 BULK INSULATION AND VAPOUR PERMEABLE SARKING

THERMAL BREAKS REQUIRED FOR STEEL FRAMED CONSTRUCTION: R0.2 (CLAD FRAMED

WALLS ONLY) EXTERNAL WINDOWS & GLASS DOORS

CORE BUILDING ALL FAÇADE: U=3.5 SHGC=0.30

COMMUNAL BUILDING ALL FAÇADE: U=2.7 SHGC=0.30

UNIT 1-7 ALL FAÇADE: U=3.1 SHGC=0.30

UNIT 7 SOUTH FAÇADE: U=3.1 SHGC=0.25

GLAZING TO COMPLY WITH AS2047

 EXTERNAL DOORS TO HAVE FOAM SEAL AROUND PERIMETER, DRAUGHT STOPPER ALONG BOTTOM EDGE AND SELF-CLOSER.

BATHROOM EXHAUST FANS TO BE FITTED WITH A SELF-CLOSING DAMPER.

AIR CONDITIONING

TO COMPLY WITH PART J6 AS APPLICABLE

PACKAGE AC UNITS TO COMPLY WITH MEPS

 SINGLE CONDITIONED ZONE OR WHEN SERVING MORE THAN 1 ZONE, THERMOSTATICALLY CONTROL THE TEMPERATURE OF EACH ZONE IN ACCORDANCE WITH J6D3

ALL A/C UNITS WITH A HEATING OR COOLING CAPACITY OF MORE THAN 2kWr TO HAVE A TIME

SWITCH CONTROLLER (REFER TO SPEC 40 OF BCA FOR DETAILS) DUCTWORK (IF INSTALLED) TO BE INSULATED TO R1.0

MECHANICAL FRESH AIR VENTILATION (IF INSTALLED) TO COMPLY WITH AS 1668.2 AND AS/NZS

TO BE DEACTIVATED IN EACH ACCOMODATION UNIT WHEN AN EXTERNAL DOOR IS OPEN FOR

MORE THAN 1 MINUTE

INTERNAL LIGHTING & POWER CONTROL OFFICE AREA - MAXIMUM ILLUMINATION POWER DENSITY OF 4.5 W/m2

COMMUNAL AREA - MAXIMUM ILLUMINATION POWER DENSITY OF 4.5 W/m2

 ACCOMMODATION UNITS - MAXIMUM ILLUMINATION POWER DENSITY OF 5 W/m2 AN OCCUPANT ACTIVATED DEVICE SUCH AS A ROOM SECURITY DEVICE, MOTION

SENSOR, CARD READER, CARD SWTICH OR THE LIKE IS TO BE INSTALLED TO CUT POWER TO LIGHTING, AIR CONDITIONER, EXHAUST FAN AND BATHROOM HEATER (IF PRESENT) WHEN AN ACCOMMODATION UNIT IS UNOCCUPIED.

EXTERNAL LIGHTING

 ALL NEW EXTERNAL LIGHTING TO BE CONTROLLED BY EITHER A DAYLIGHT SENSOR OR TIME SWITCH AND WHERE TOTAL PERIMETER LIGHTING EXCEEDS 100W HAVE A MINIMUM OF 90% OF LIGHT FITTINGS TO BE LEDS OR BE CONTROLLED BY A MOTION SENSOR.

FAÇADE LIGHTING OR ILLUMINATED SIGNS TO BE CONTROLLED BY A TIME SWITCH OR

DAYLIGHT SENSOR. HOT WATER SUPPLY

 HEATED SANITARY WATER SYSTEMS TO BE DESIGNED AND INSTALLED AS PER PART B2 NCC VOL. 3

BOILING / CHILLED WATER UNITS (IF ANY)

TO BE CONTROLLED BY A TIME SWITCH.

METERING OF GAS / ELECTRICITY

ELECTRICITY METER (AS PER SUPPLY AUTHORITY REQUIREMENTS) TO BE INSTALLED


MAIN SWITCHBOARD WITH PROVISION FOR FUTURE SOLAR PV/BATTERY SYSTEM


20% OF ROOF SPACELEFT CLEAR FOR FUTURE SOLAR PV SYSTEM

SUB METERING IS NOT REQUIRED


AMENDMENT ISSUE BY PLAN STATUS 21/08/23DA SUBMISSION JOB No. | REVISION | SCALE 17/11/23 RFI AMENDMENTS/ACCESS RAMP/RETAINING DETAILS REV B CCH/CC DRAWN PRINT DATE DRAWING No. CCH | 17/11/2023 | 1 of 19

PROPERTY DESCRIPTION LOT 1 / DP38393 REFER TO SHEETS 6 & 7 FOR 271 BERNHARDT STREET, EAST ALBURY RETATINING WALL DETAILS SITE AREA - 3,916.15.m² P-02 (P-01) SITE NOTES SUGGESTED SEWERLINE & MANHOLES BERNHARDT STREET & MANHOLES THE SITE INCLUDING BATTERS AND PROVIDE SEDIMENTATION BRICK ANDTIMBER PAUNG CONTROL AFTER HANDOVER IF REQUIRED. POWERLINES ALL STORMWATER AND DRAINAGE TO BE IN ACCORDANCE WITH CURRENT NCC PLUMBING CODE OF AUSTRALIA VOL. 3 OMERI EAD (SECTION D) IN ADDITION TO AS/NZS. 3500. ENSURE 100mm DIAMETER AGRICULTURAL DRAINS ARE TBM LOT2 PROVIDED TO THE BASE OF ALL CUTS AND RETAINING CONCINAL WALLS AND ARE CONNECTED TO THE STORMWATER DP38393 NKERB SYSTEM VIA SCREENED SILT PITS AS REQUIRED. 11111111 RL:189.08(AHD) EXTERNAL FINISHED SURFACES SURROUNDING THE BRICK DWELLING FROM THE BUILDING GRADED TO A SLOPE NOT LESS THAN 50mm OVER THE FIRST 1000mm FROM THE BUILDING. RENDER LOT3 LOT5 LOT6 LOT4 RETAINING WALL DWELLING DP38393 DP38393 DP38393 DP38393 SPOON DRAIN & EARTH BERM TO DIVERT OVERLAND SURFACE 11111111 WATER AROUND BUILDING PAD. BRICK RESIDENCE [RENDER] BRICK RESIDENCE BRICK RESIDENCE BRICK RESIDENCE [RENDER] ROOF TILE **ROOF TILE ROOF TILE ROOF TILE** SP13263 THE HEIGHT OF OVERFLOW RELIEF GULLIES (ORG) RELATIVE TO 14% DRAINAGE FITTINGS AND GROUND LEVEL MUST BE A MINIMUM OF 150mm BELOW THE LOWEST SANITARY FIXTURE. RETAINING WALL (11111111111) RETAINING WALL CONNECT DOWNPIPES TO LEGAL POINT OF DISCHARGE VIA TOP OF PARAPET:190.63 100mm DIAMETER UPVC STORMWATER PIPE LAID WITH A RETAINING WALL MINIMUM FALL OF 1:100. DISCHARGE IN ACCORDANCE WITH LOCAL AUTHORITY REQUIREMENTS. FLOORLEVEL:187.97 DISCHARGE STORMWATER TO LOCAL AUTHORITY REQUIREMENTS. 111111 PROVIDE ABLEFLEX EXPANSION JOINT FILLER BETWEEN HOUSE AND DRIVEWAY/TERRACE/PORCH SLAB. GRASS AREA SHED | FILL BATTER GRADIENT @ 1 : 2 WHERE ACHIEVABLE (MAX. 1 RETAINING WALL 1.5), CUT BATTER GRADIENT @ 1:1.5 LOT2 DP1118986 | SEDIMENT CONTROL BARRIER AS REQUIRED FOR CONSTRUCTION PURPOSES ONLY GRASS AREA GRASS AREA CRASS LEGEND AREA PAD LEVEL FLOOR LEVEL CONCRETE BLOCK RETAINING WALL PROPOSE RAIN GARDEN REDUCED LEVEL (RW-10) 98⁰52' RETAINING WALL SURVEY LEGEND A SITH SHITTPOST & SAME AND SAME STEEL SHEET POST & RAL-------EXISTING SURFACE TREE TRUNK 1m HIGH TIMBER FENCE GRATED PIT INVERT COMMUNICATIONS PIT GRASS AREA COMMUNICATIONS MARKER POST GAS METER PL+185,571 FL+185,891 FIRE HYDRANT WATER METER 111117 BRICK RESIDENCE WATER TAP **ROOF TILE** LOT51 DP774842 UNCLASSIFIED PIT GATE SHED FL+184,400 SEWER PIT LID SEWER INSPECT SHAFT 1111 RETAINING WALL GRASS AREA DP1063552 CENTRELINE OF BITUMEN DP38393 CRASS AREA _____ EDGE OF CONCRETE 0750mm RCP DRIVEWAY EDGE OF FORMATION RETAINING WALL BACK OF KERB RETAINING WALL AWNING BUILDING PL+184,637 FL+184,957 PL+184,880 FL+185,200 HOUSE 182.63 **CRASS** SHED STOCKPILE AREA — — — TOE OF BANK — — — TOP OF BANK VEGETATION (MACH HASE) I MACH MACH — — — OVERHEAD POWERLINES LOT1 DP78431 RETAINING WALL ————s——— SEWER MAINS RETAINING WALL FENCE SLEEPER PROPOSED ---- EXISTING DRAINAGE PARKING EASEMENITIO DRANWATER 6 WIDE INVERT:183.57 INVERT:181.90 INVERT 183.56 0750mm RCP _____ 0750mm RCP SIEELSHEETPOST& RAL SHED •THIS DRAWING HAS BEEN PRODUCED BASED ON INFORMATION SUPPLIED BY OTHERS. HOUSING PLUS WILL NOT BE HELD RESPONSIBLE FOR THE **AMENDMENT** ISSUE BY PLAN STATUS PROJECT ADDRESS DESIGN & ARCHITECTURE PROJECT MANAGER BASIX CONSULTANT DRAWING TITLE 271 BERNHARDT STREET, EAST ALBURY NSW 2640 DARREN WOODING MICHAEL KIHO PROPOSED ALBURY CORE & CLUSTER HOUSING PLUS 21/08/23DA SUBMISSION PH: TBC PH: 0400 680 815 PH: TBC •THE WORKS DESCRIBED ON THIS DRAWING ARE COVERED BY COPYRIGHT. JOB No. | REVISION | SCALE WITH 7 DWELLINGS & COMMUNITY FACILITY 17/11/23 RFI AMENDMENTS/ACCESS RAMP/RETAINING DETAILS REV B CCH/CC PROPOSED SITE PLAN WORKS CANNOT BE COPIED OR REPRODUCED BY ANY MEANS WITHOUT 001 WRITTEN PERMISSION OF HOUSING PLUS LANDSCAPE CONSULTANT HYDRAULIC STRUCTURAL/CIVIL *BUILDER'S WRITTEN SPECIFICATIONS TAKE PRECEDENCE OVER PLAN DETAILS, COLOURS, FITTINGS AND FIXTURES. TRICEND ENGINEERING TRICEND ENGINEERING TBC DRAWN PRINT DATE DRAWING No. PH: 13 227 676 PH: 13 227 676 PH: TBC 13 Byng Street, Orange NSW 2800 | E: design@housingplus.com.au CCH | 17/11/2023 | 4 of 19

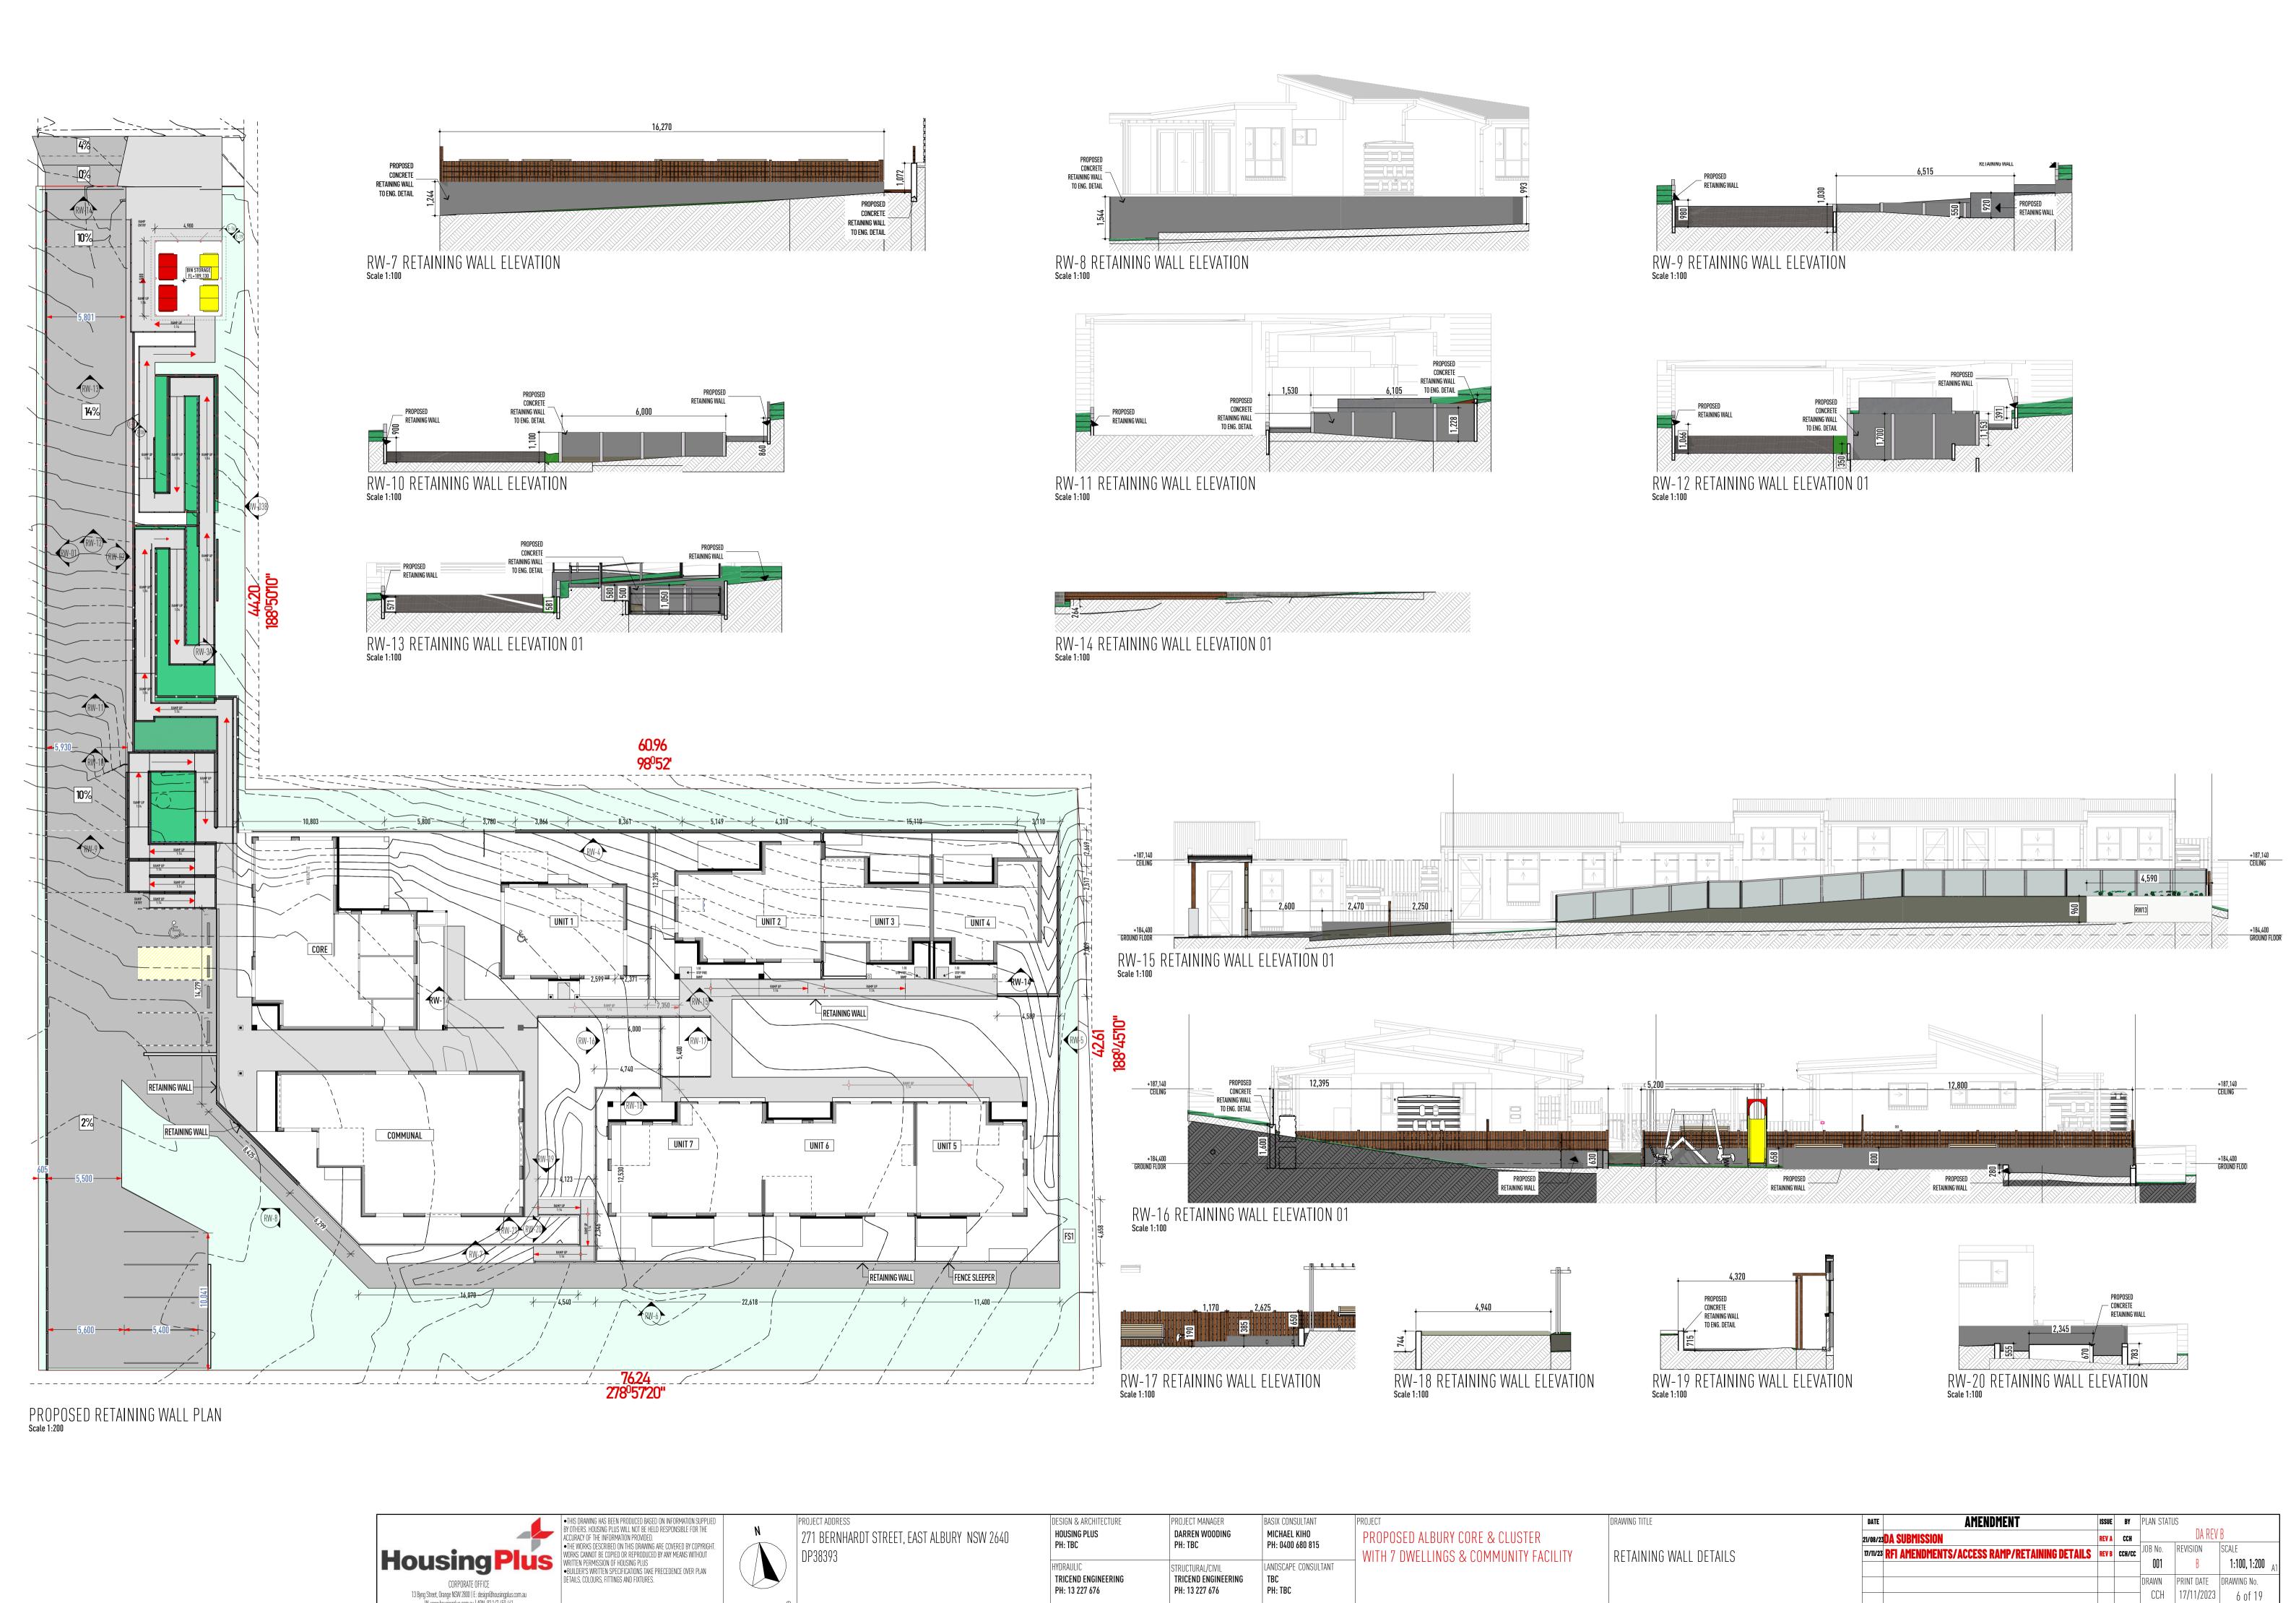

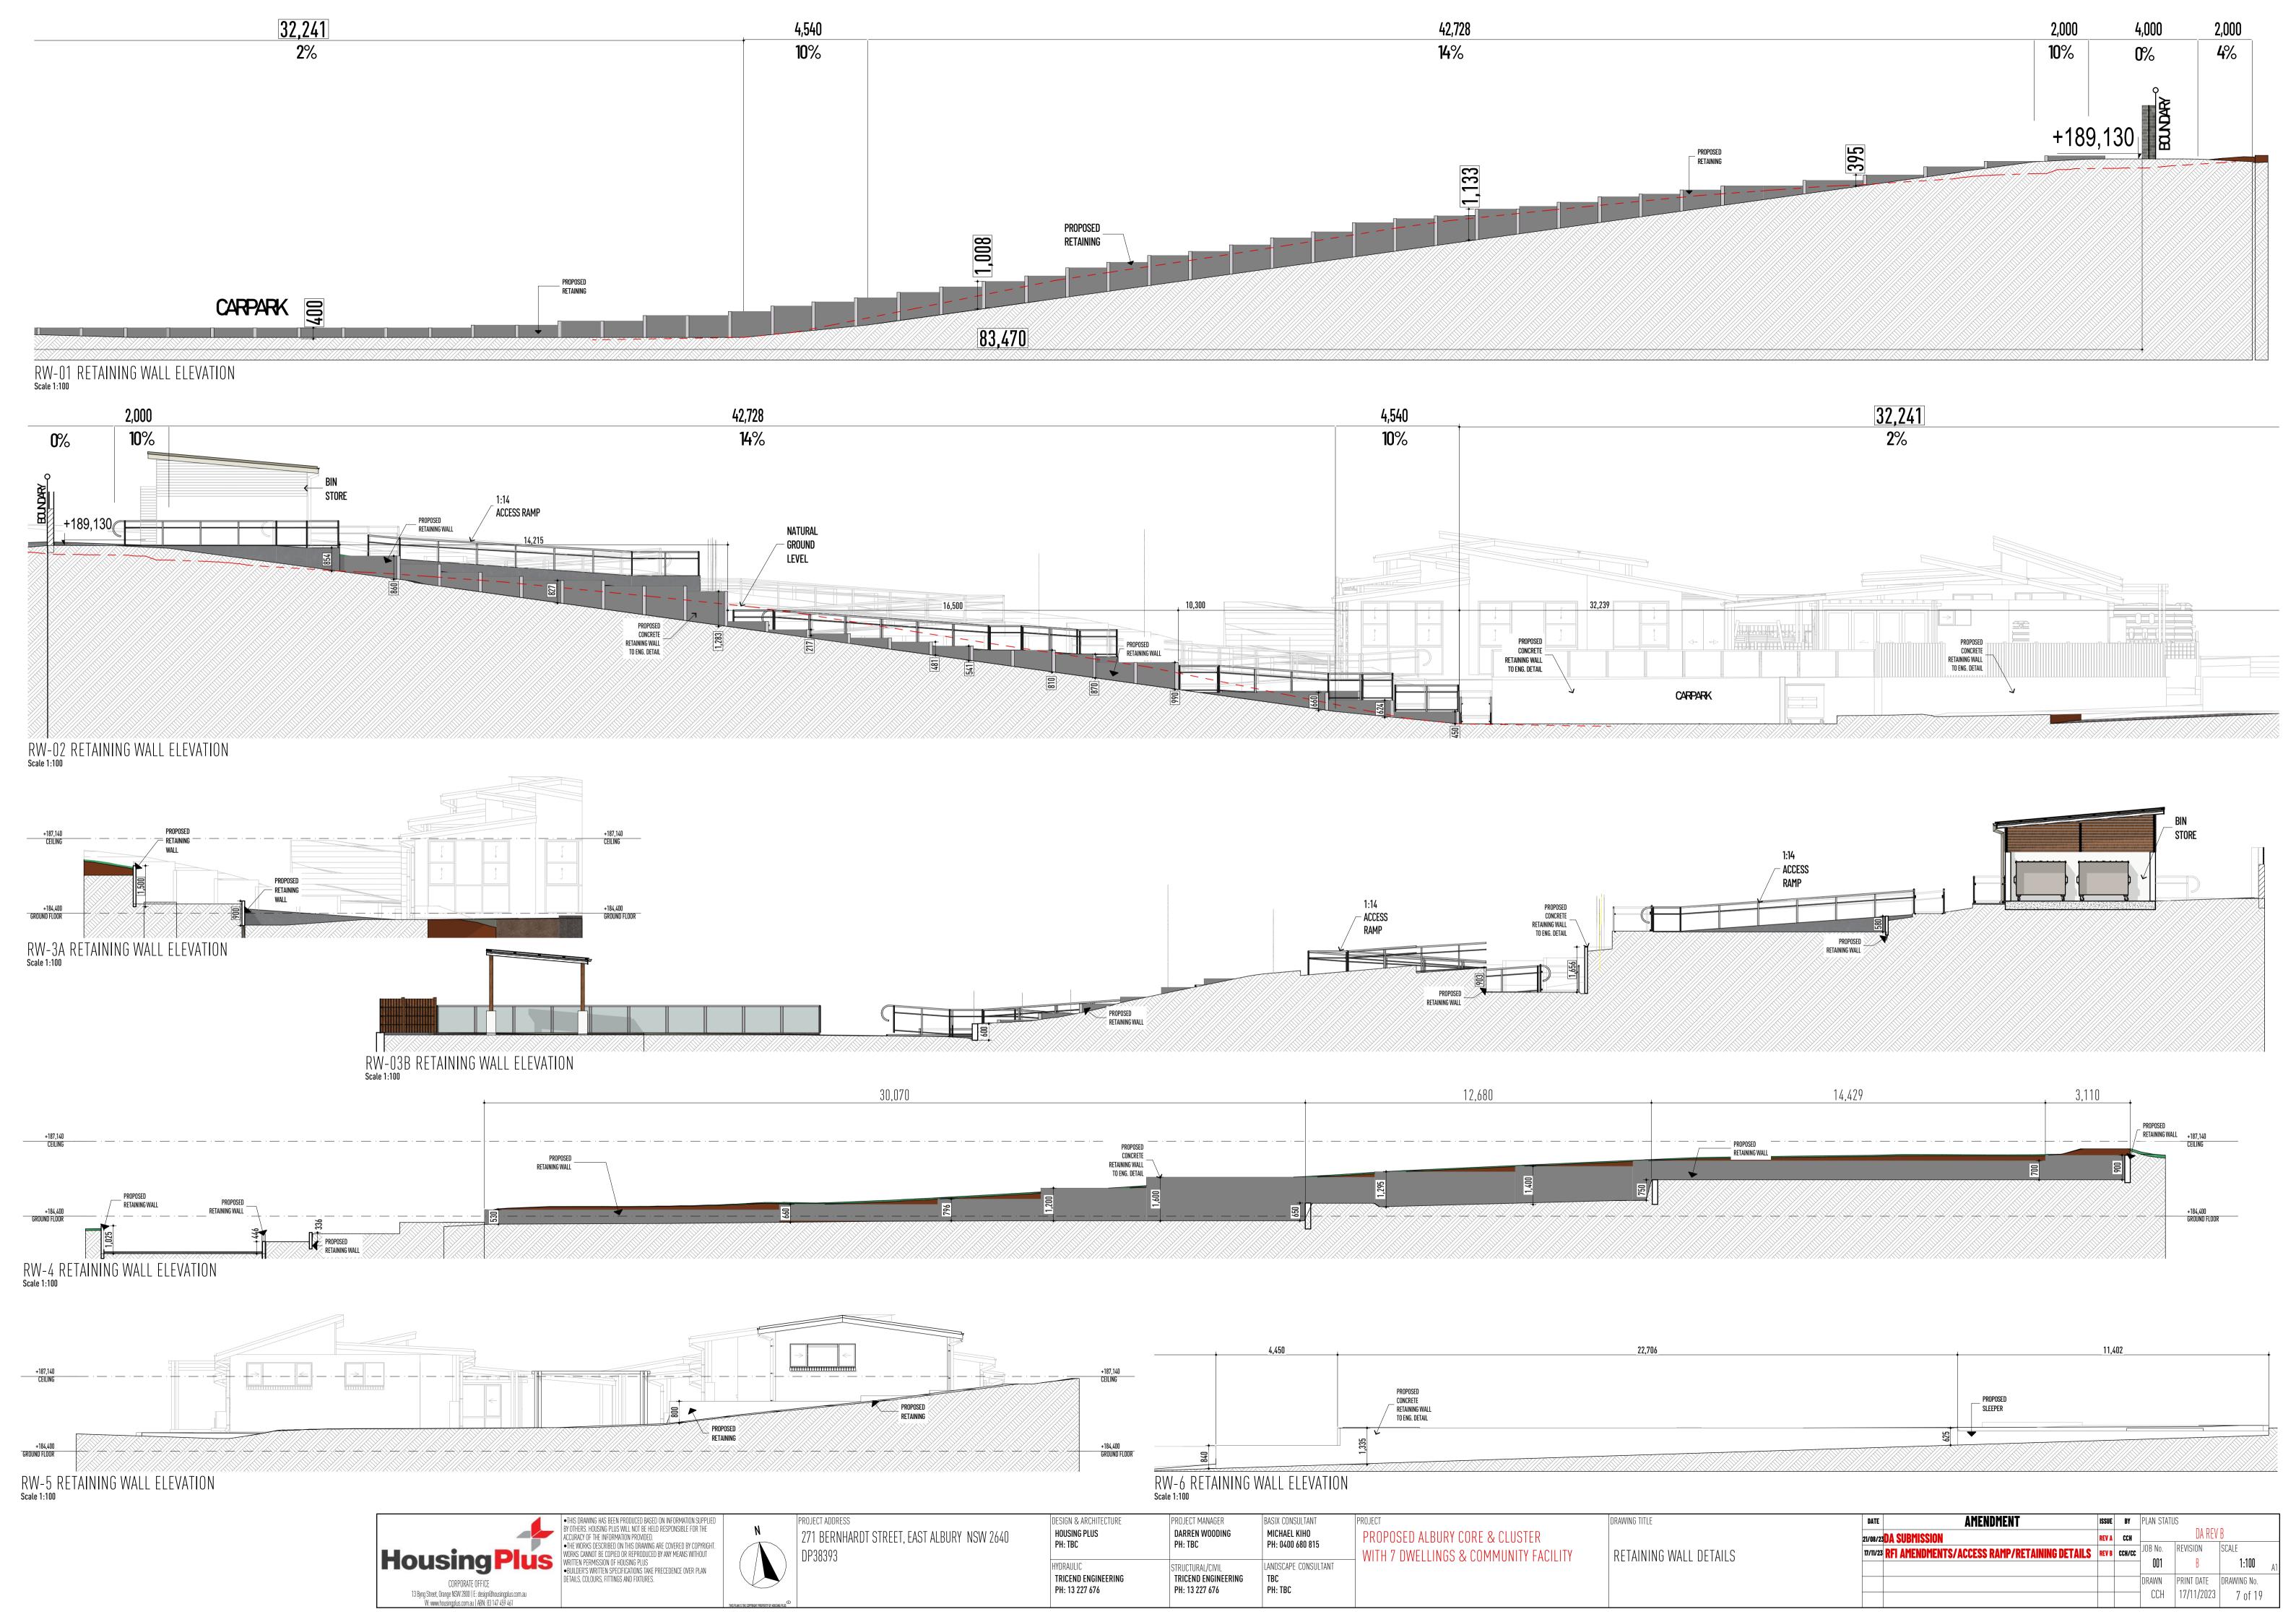



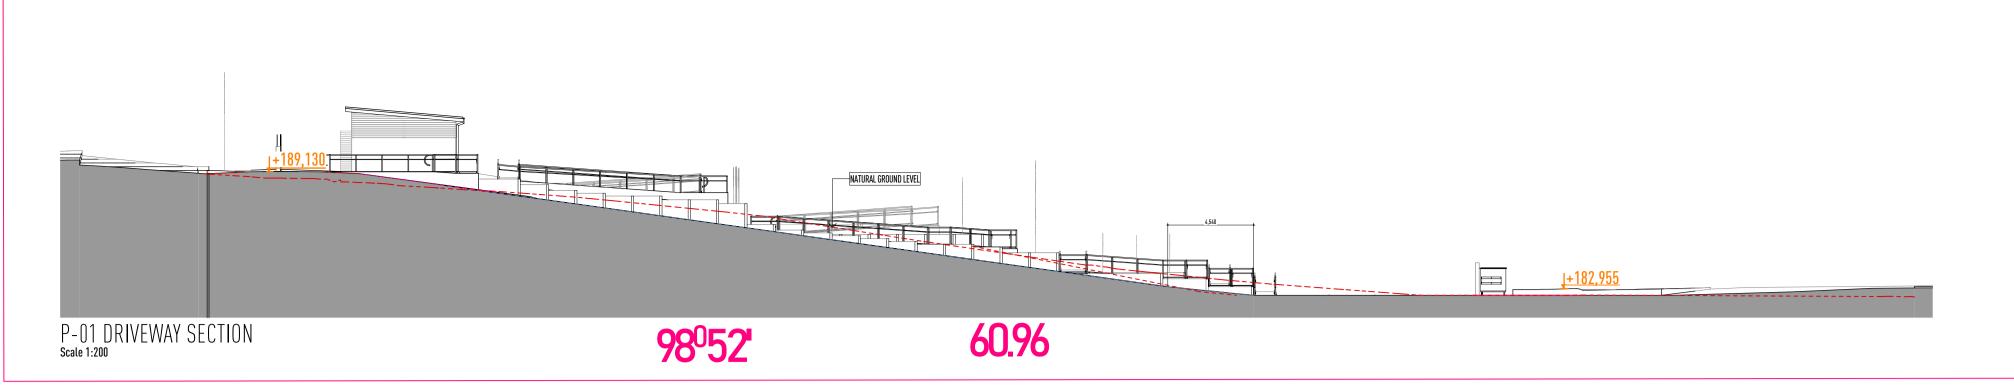

ROOF AREA AREA SURFACE AREA
 PIICH
 AREA
 SURFACE AREA

 3.00°
 152.54
 152.74

 5.00°
 186.11
 186.82

 8.00°
 249.24
 251.69

 10.00°
 173.90
 176.57

 12.00°
 98.74
 100.94


 18.00°
 140.17
 147.39

 1,000.70 m²
 1,016.15 m²

GUTTER, FASCIA AND DOWNPIPES TO BE INSTALLED TO MANUFACTURER'S DETAILS AND TO COMPLY WITH CURRENT

ROOFING TO BE FIXED IN ACCORDANCE WITH MANUFACTURER'S SPECIFICATIONS FOR ENGINEER'S WIND RATING CONDITIONS

STEEL ROOFING TO COMPLYWITH AS1562.1 PROVIDE ALCOR BARRIER BETWEEN LEAD FLASHING AND ZINCALUME VALLEY GUTTER AS REQUIRED.

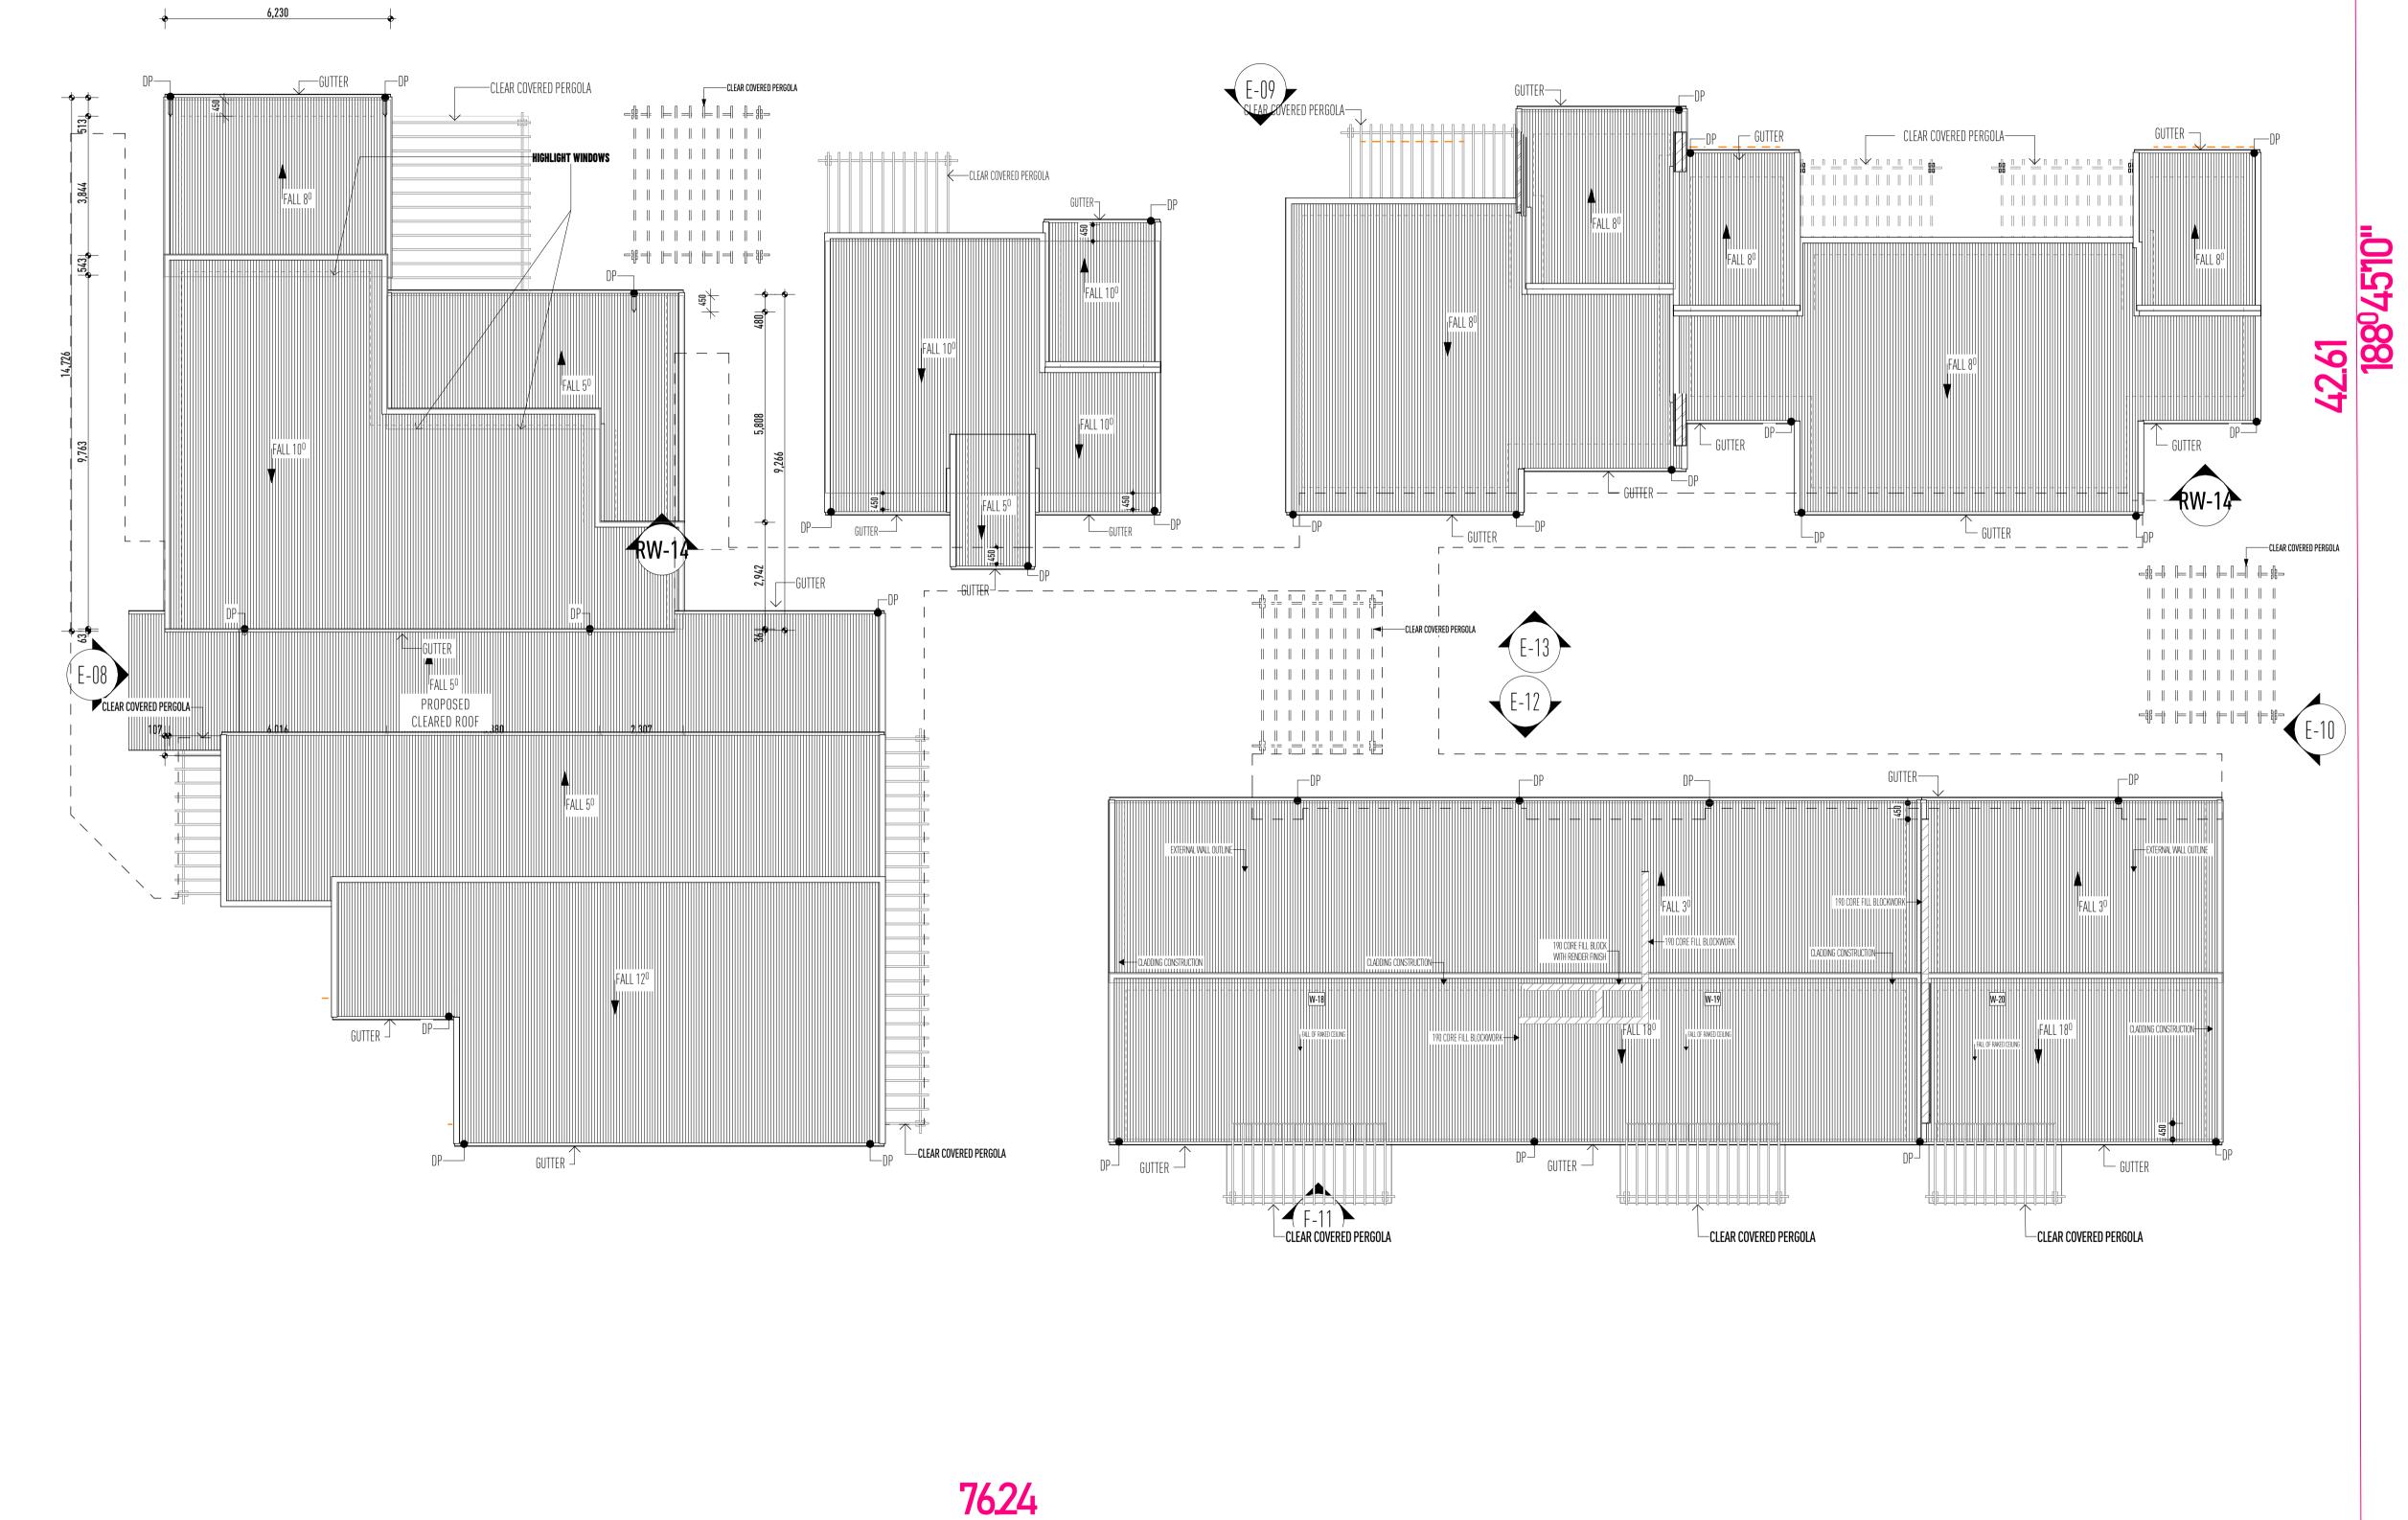



13 Byng Street, Orange NSW 2800 | E: design@thousingplus.com.au W: www.housingplus.com.au | ABN: 83 147 459 461

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PROJECT ADDRESS

271 BERNHARDT STREET, EAST ALBURY NSW 2640

DESIGN & ARCHITECTURE PROJECT MANAGER HOUSING PLUS DARREN WOODING PH: TBC PH: TBC HYDRAULIC STRUCTURAL/CIVIL TRICEND ENGINEERING TRICEND ENGINEERING PH: 13 227 676 PH: 13 227 676

TBC

PH: TBC

278⁰57'20"


BASIX CONSULTANT PROJECT MICHAEL KIHO PROPOSED ALBURY CORE & CLUSTER PH: 0400 680 815 WITH 7 DWELLINGS & COMMUNITY FACILITY LANDSCAPE CONSULTANT

PROPOSED ROOF PLAN AND DRIVEWAY SECTION

DRAWING TITLE

AMENDMENT ISSUE BY PLAN STATUS 21/08/23DA SUBMISSION 17/11/23 RFI AMENDMENTS/ACCESS RAMP/RETAINING DETAILS REV B CCH/CC JOB No. REVISION SCALE 001 DRAWN PRINT DATE DRAWING No. CCH | 17/11/2023 | 9 of 19

1:100

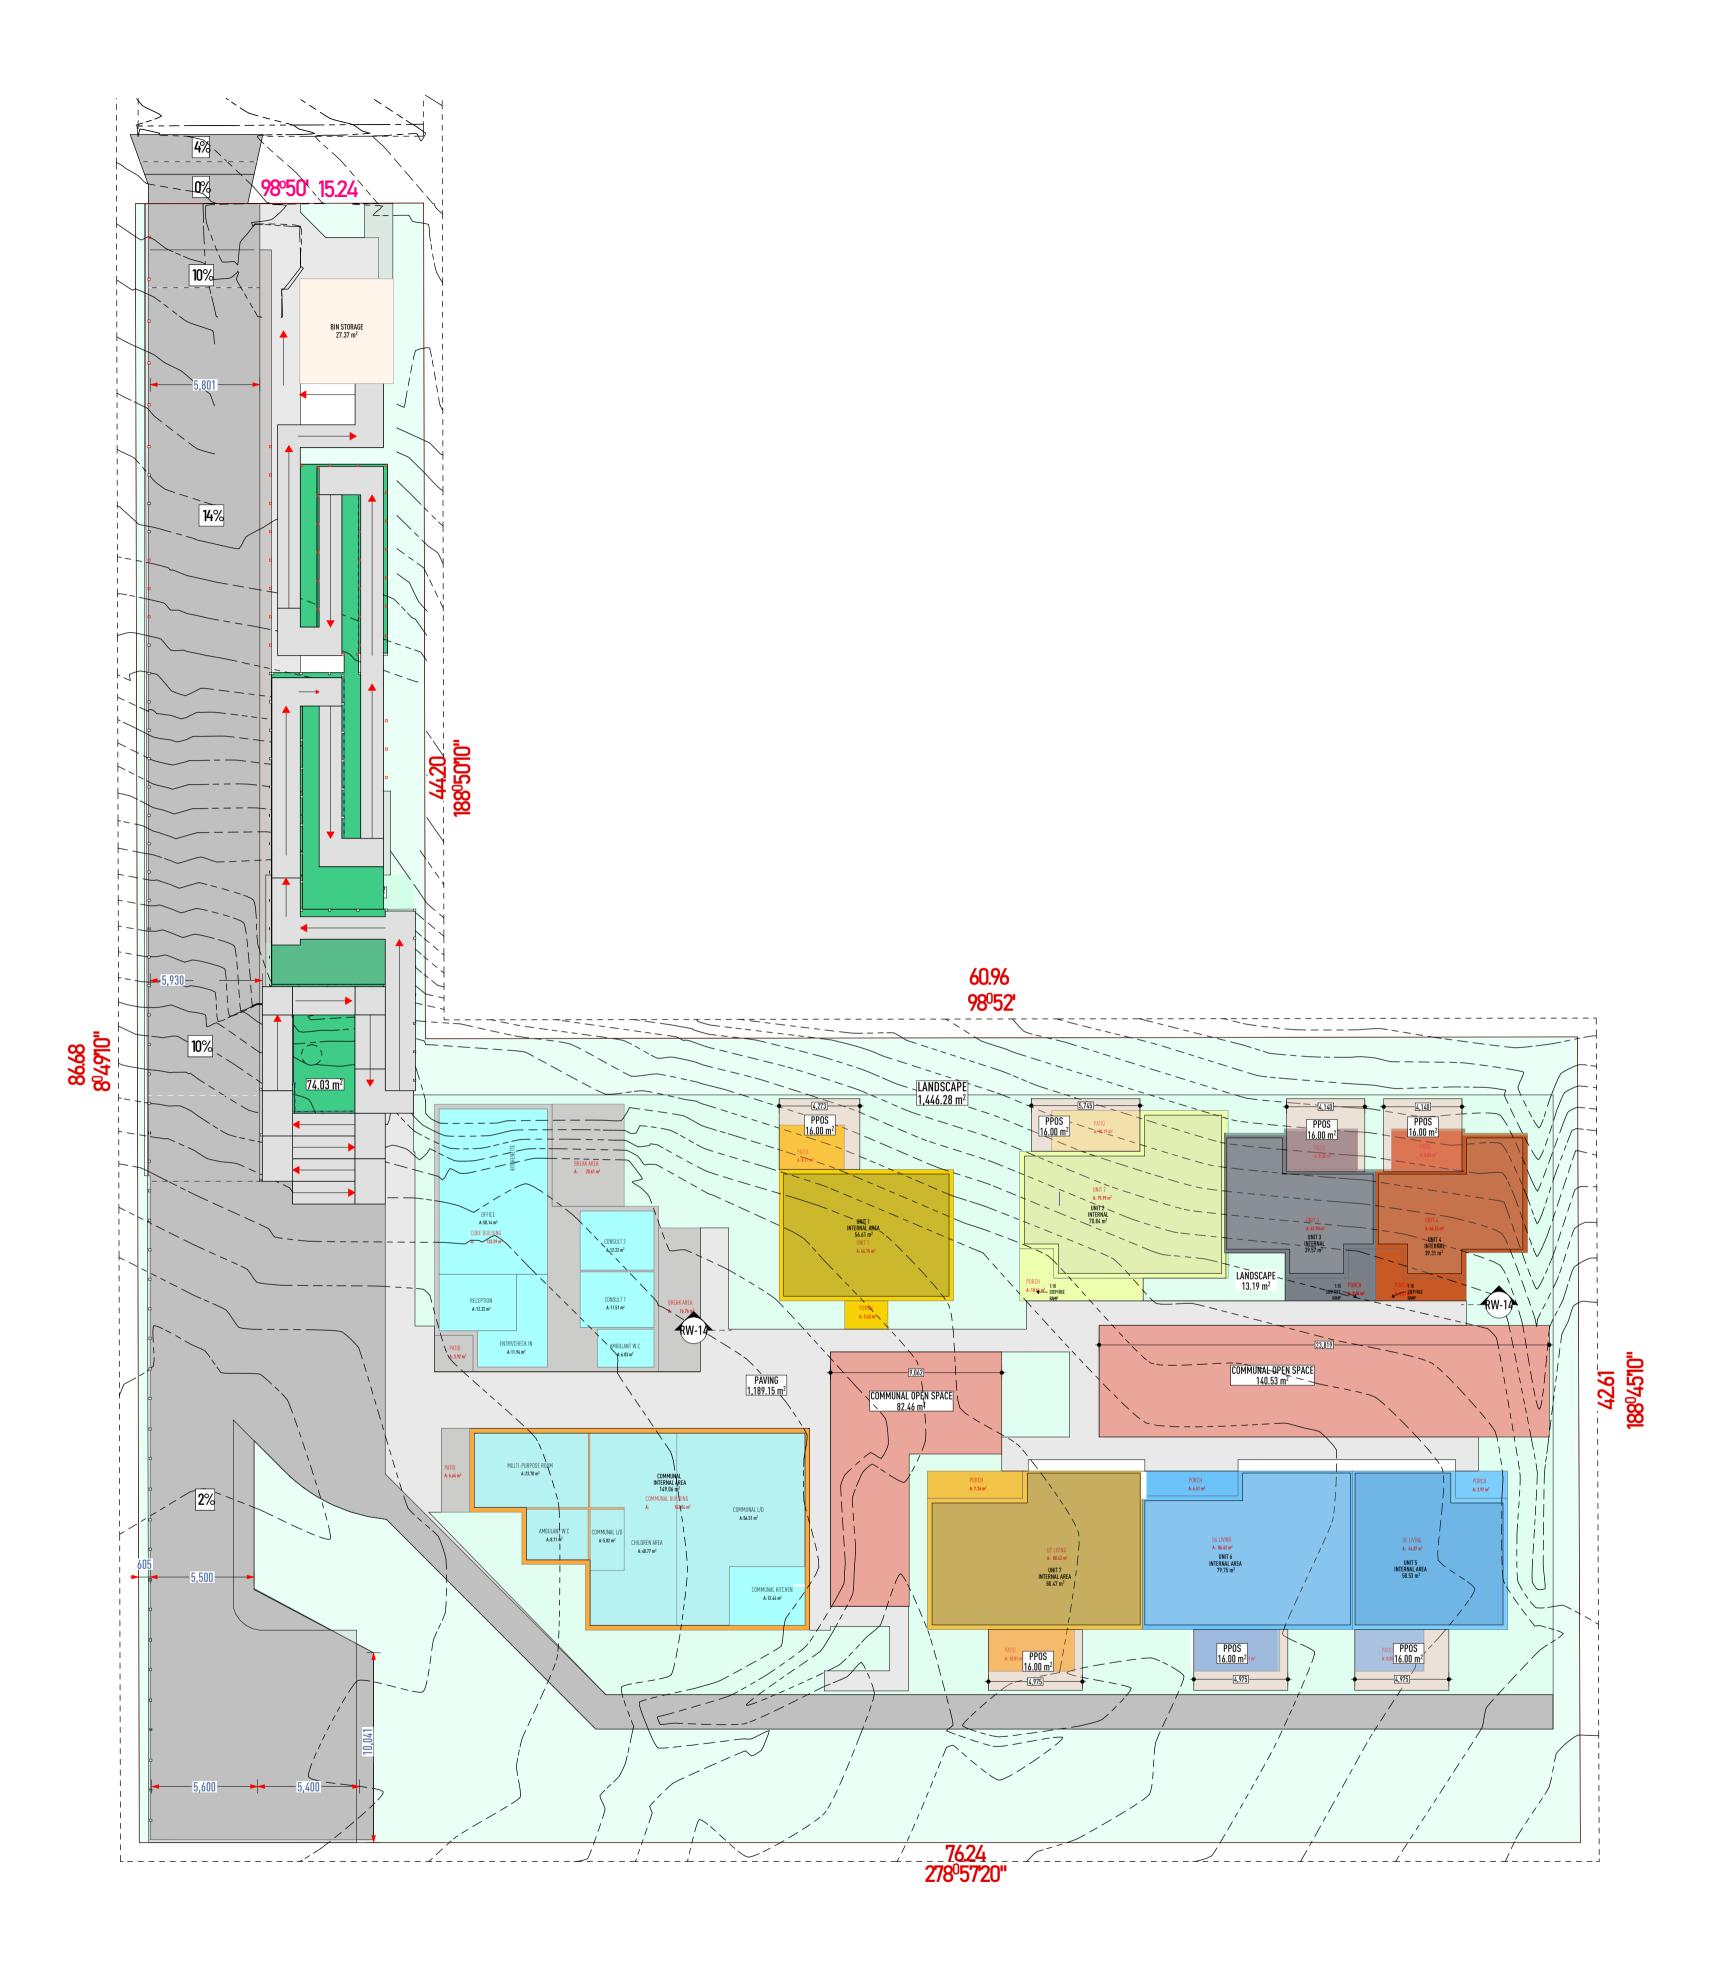

PROPERTY DESCRIPTION
LOT 1 / DP38393
271 BERNHARDT STREET, EAST ALBURY
SITE AREA - 3,916.15.m²


	AREA CALCULATIO	N -
BREAK A	AREA	37.
CORE B	UILDING	133
PATI0		10.
		18′
F	AREA CALCULATION	COM
COMM	UNAL BUILDING	16
		16
	AREA CALCULATIO	\ - (
PATI0		8.1
PORCH		3.4
UNIT 1		64.
		75
	AREA CALCULATIO	\ - \
PATI0		10.
PORCH		10.
UNIT 2		79.
		101
	AREA CALCULATIO	\ - \
PATI0		8.0
PORCH		15.
UNIT 3		45.
		69.
	AREA CALCULATIO	\ - (
PATIO		8.0
PORCH		8.0
UNIT 4		46.
	1051 011 0111 17:0:	62.
	AREA CALCULATIO	√ - l
PATI0		8.0
PORCH		3.9
U5 LIVII	NG	64.
		76.
	AREA CALCULATIO	\ - l
PATI0		10.
PORCH		6.5
11/11/14	uc.	07


LANDSCAPE
SOFT LANDSCAPE: 1,654.28m ²
HARD LANDSCAPE: 1,189.15m ²


AREA CALCULATION - UNIT 7


103.14 m²


105.70 m²

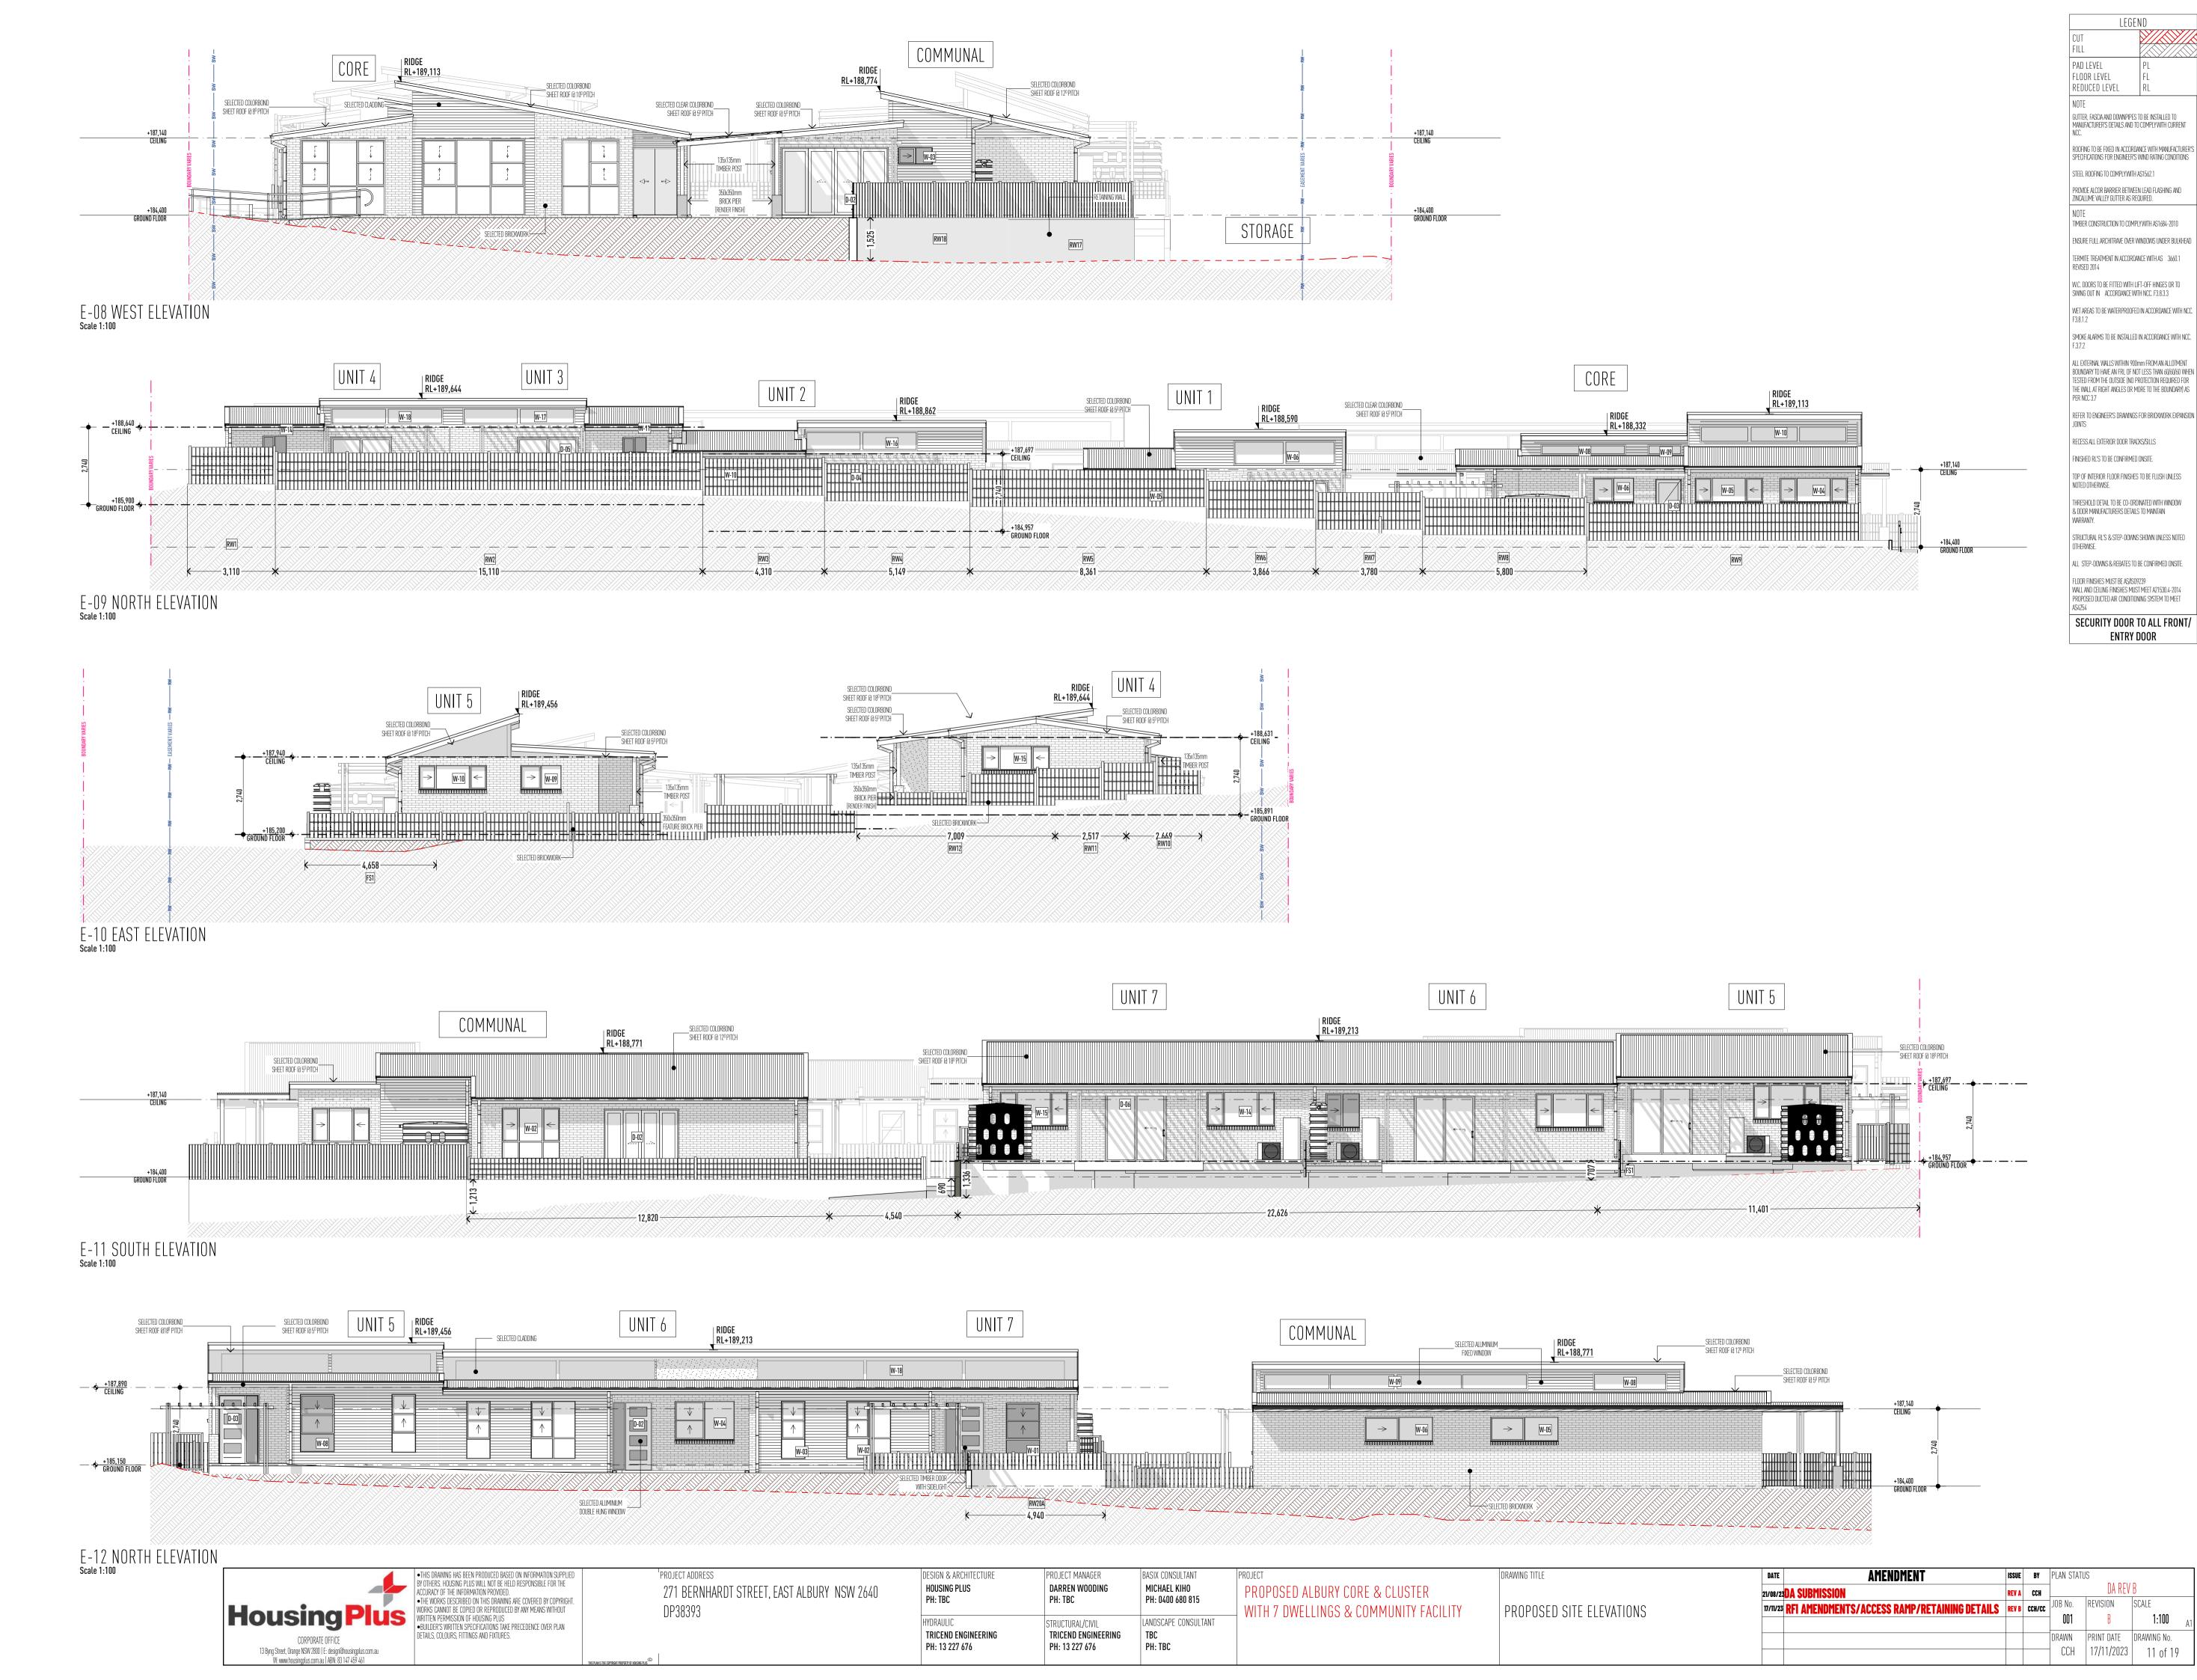

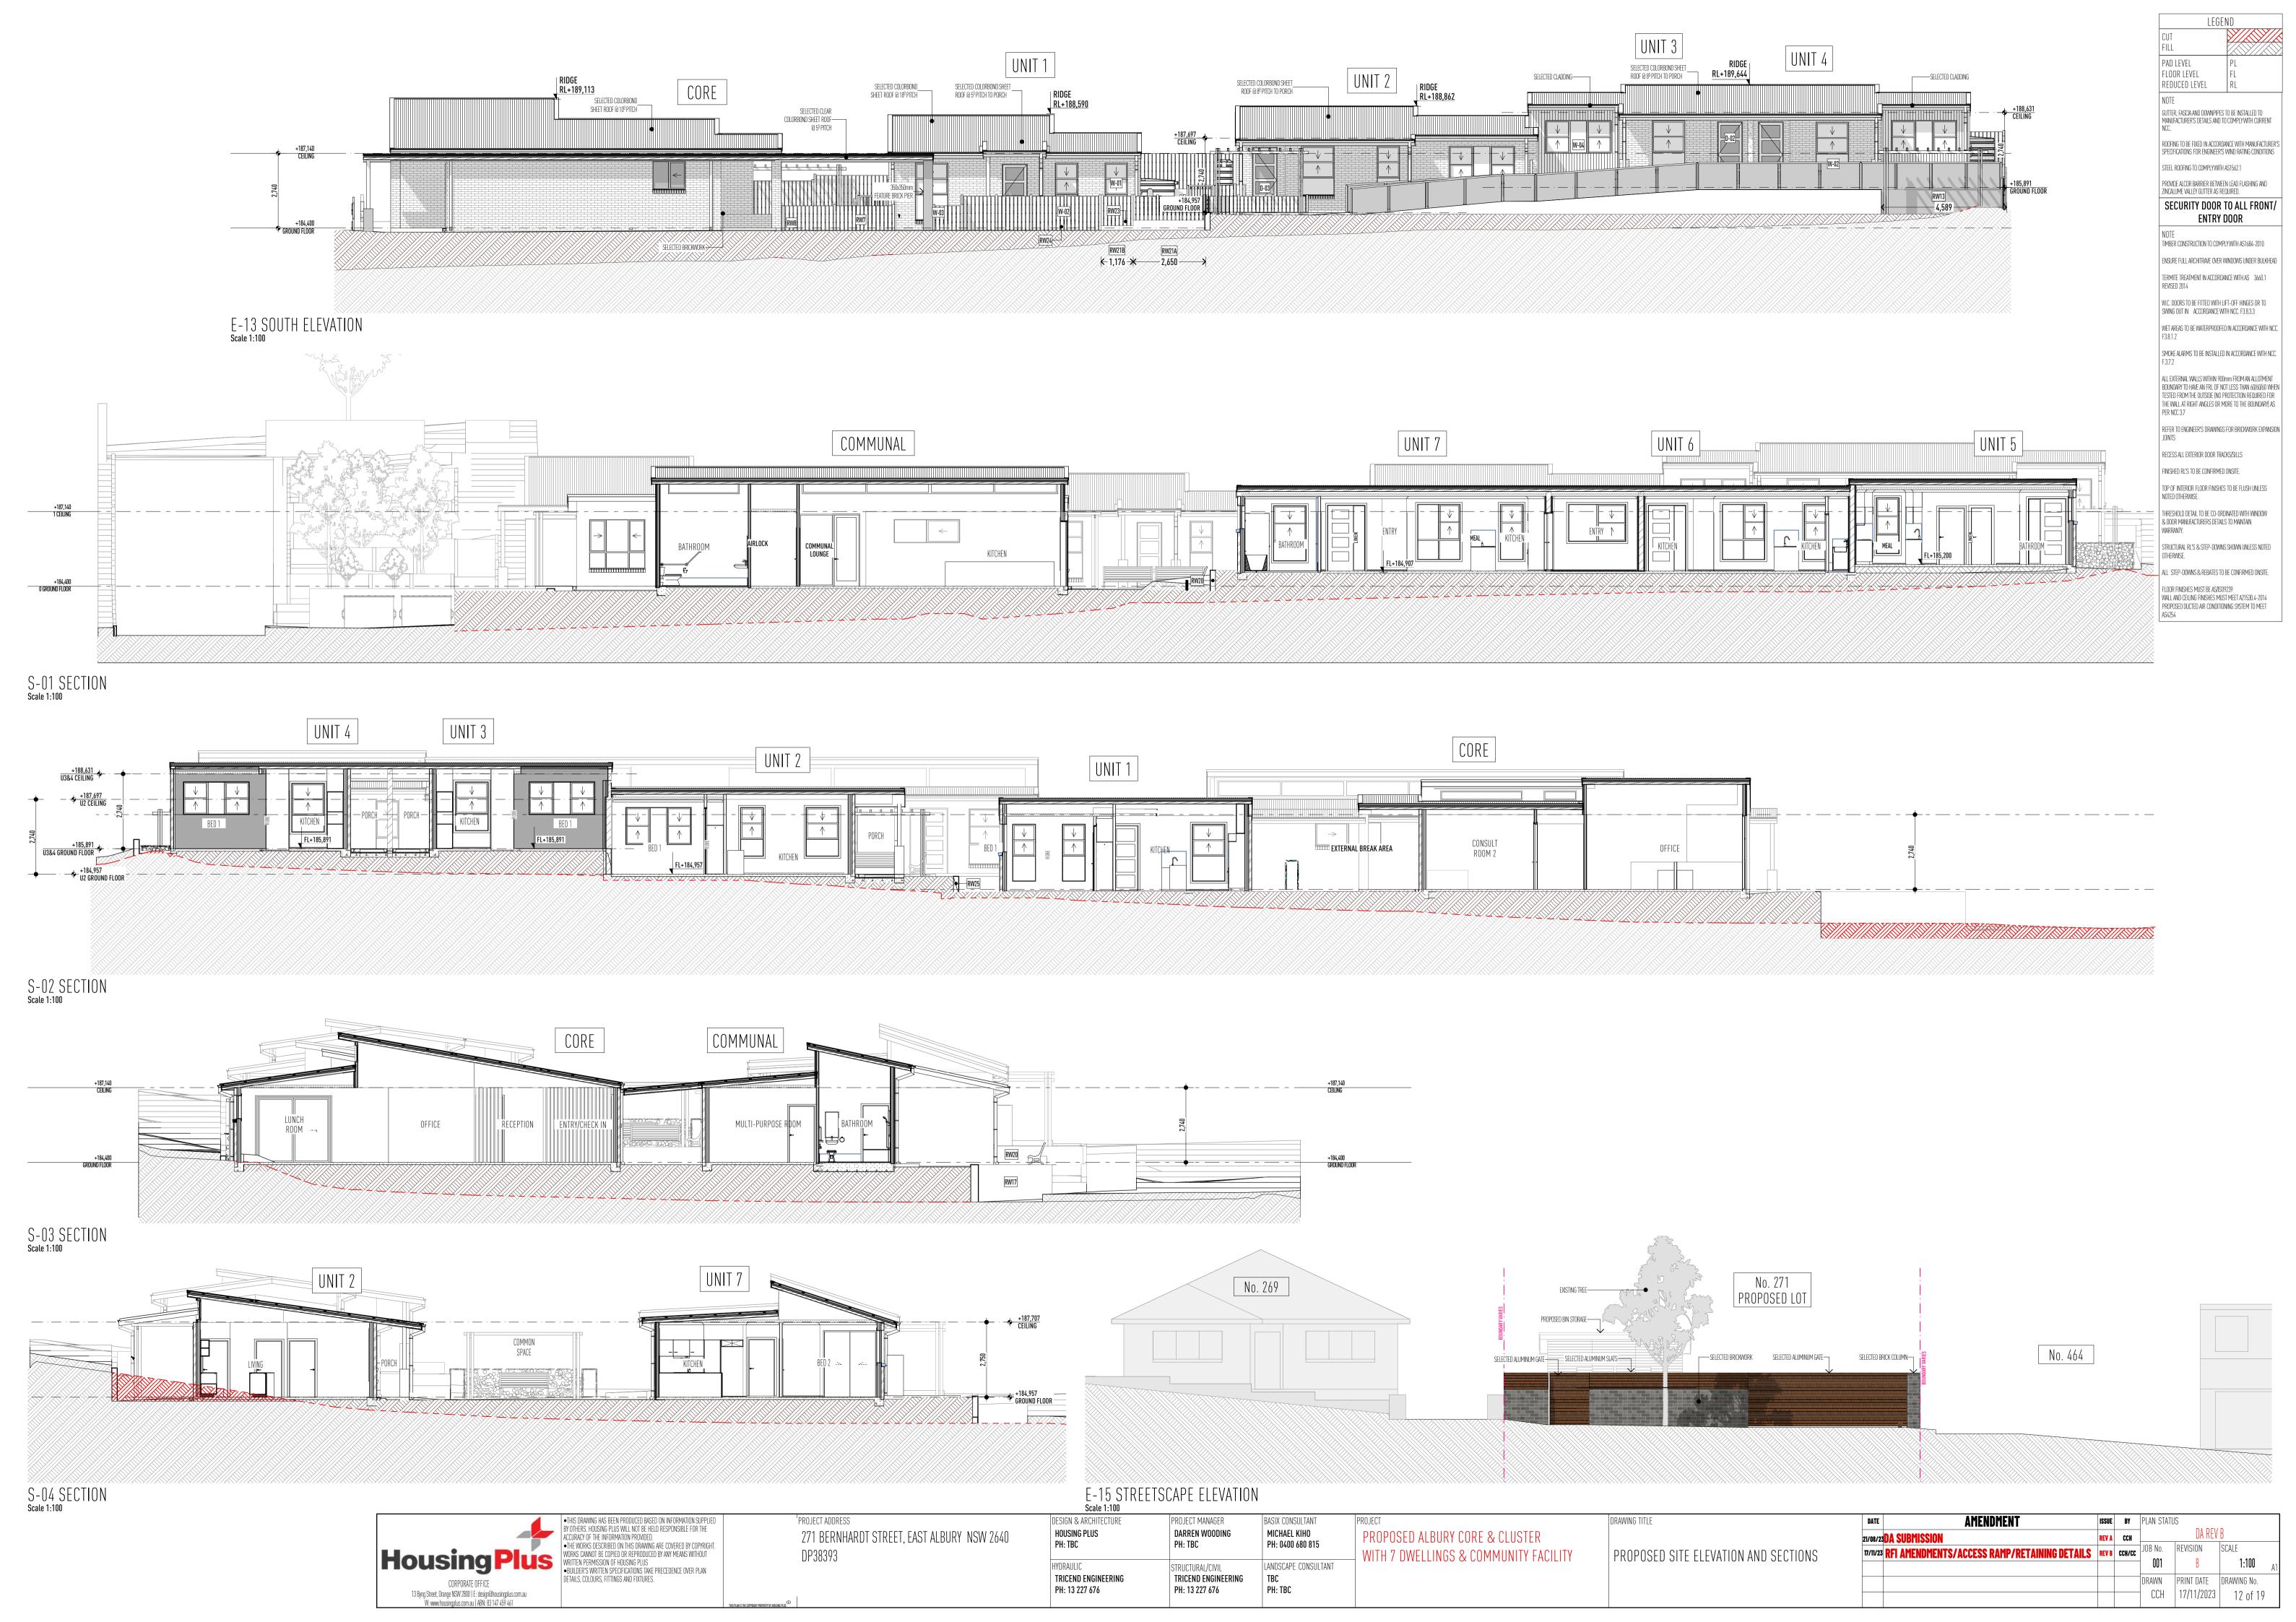

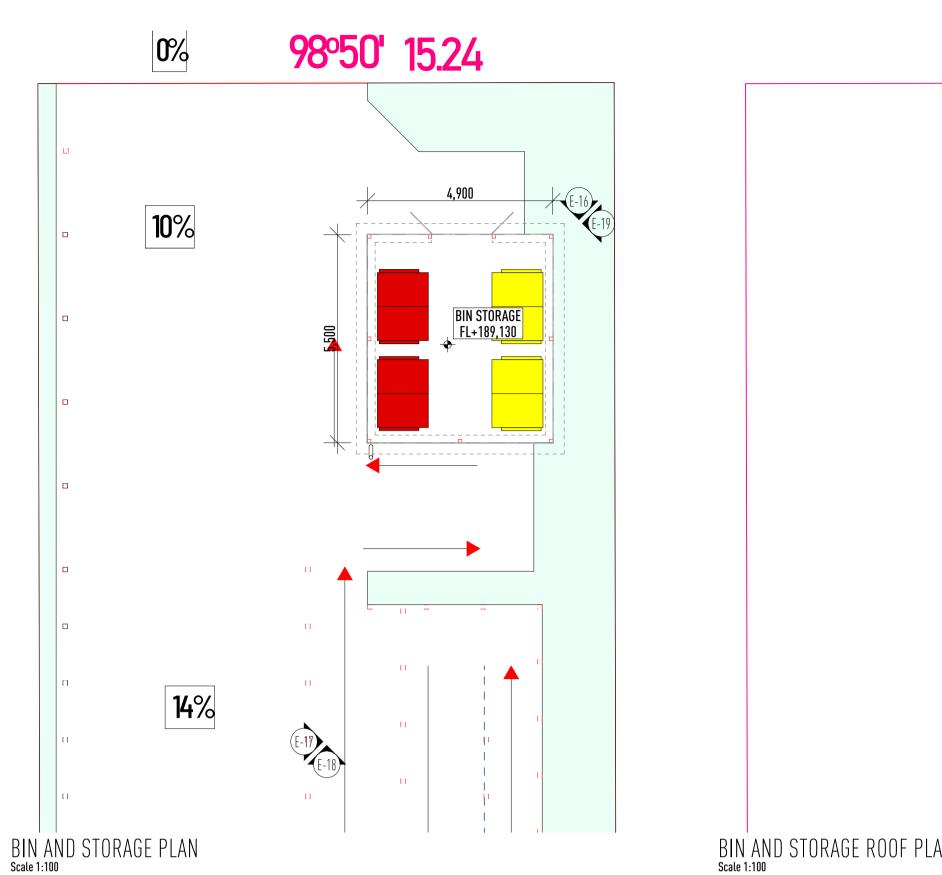

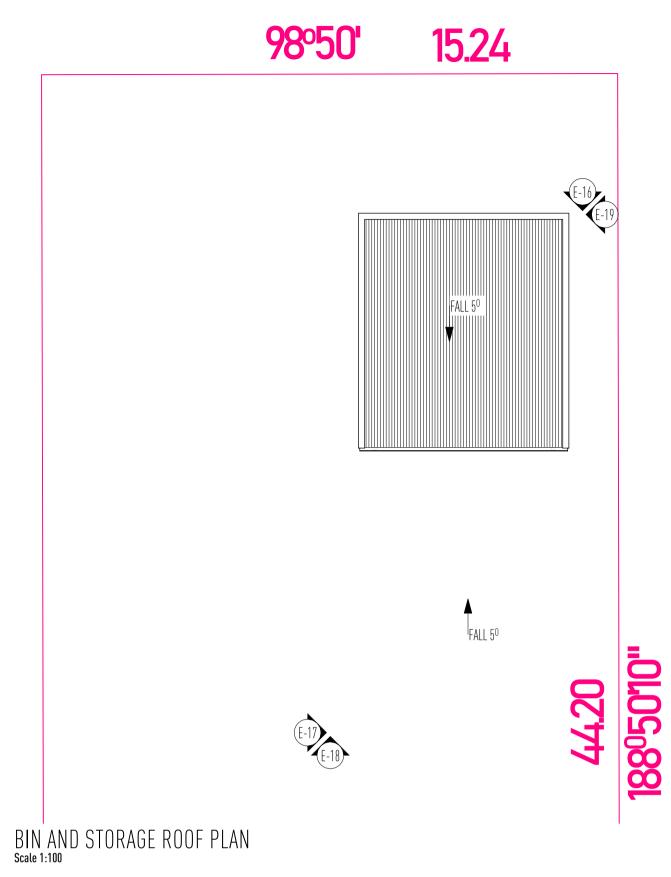

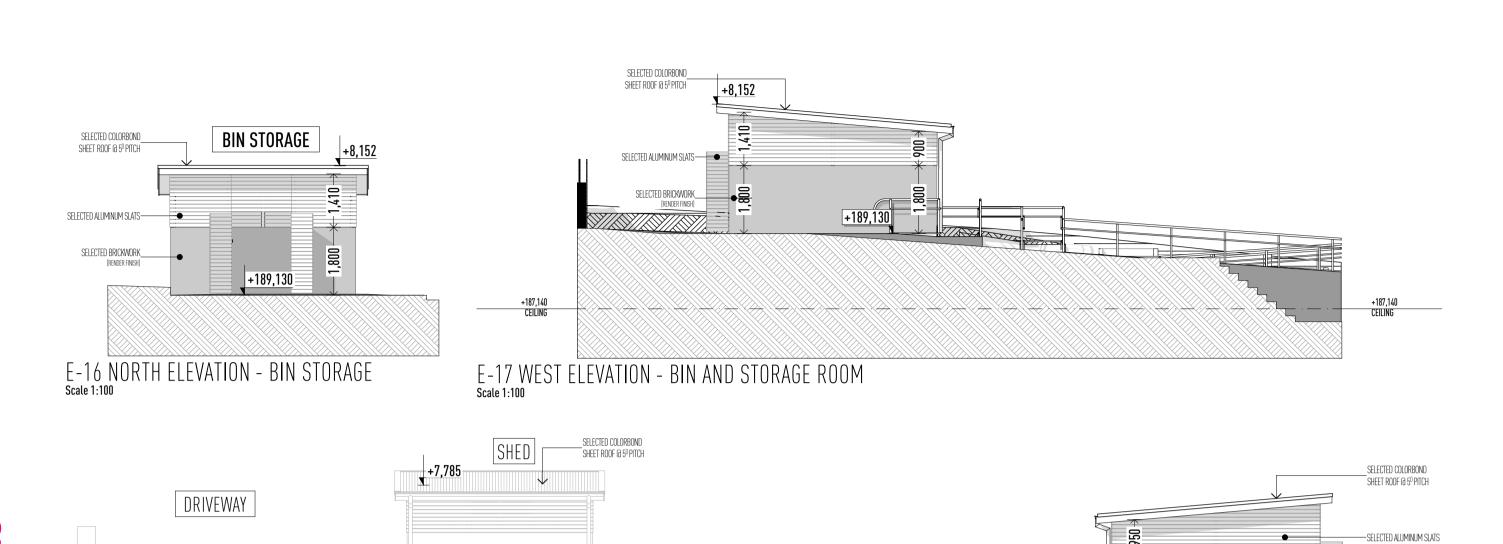

E-19 EAST ELEVATION BIN AND STORAGE ROOM Scale 1:100

SELECTED COLORBOND SHED

E-18 SOUTH ELEVATION - STORAGE ROOM Scale 1:100 SECURITY DOOR TO ALL FRONT/ ENTRY DOOR

GUTTER, FASCIA AND DOWNPIPES TO BE INSTALLED TO MANUFACTURER'S DETAILS AND TO COMPLY WITH CURRENT

ROOFING TO BE FIXED IN ACCORDANCE WITH MANUFACTURER'S SPECIFICATIONS FOR ENGINEER'S WIND RATING CONDITIONS

STEEL ROOFING TO COMPLYWITH AS1562.1

PROVIDE ALCOR BARRIER BETWEEN LEAD FLASHING AND ZINCALUME VALLEY GUTTER AS REQUIRED.

TIMBER CONSTRUCTION TO COMPLY WITH AS1684-2010

ENSURE FULL ARCHITRAVE OVER WINDOWS UNDER BULKHEAD

TERMITE TREATMENT IN ACCORDANCE WITH AS 3660.1

W.C. DOORS TO BE FITTED WITH LIFT-OFF HINGES OR TO SWING OUT IN ACCORDANCE WITH NCC. F3.8.3.3

WET AREAS TO BE WATERPROOFED IN ACCORDANCE WITH NCC.

SMOKE ALARMS TO BE INSTALLED IN ACCORDANCE WITH NCC.

ALL EXTERNAL WALLS WITHIN 900mm FROM AN ALLOTMENT BOUNDARY TO HAVE AN FRL OF NOT LESS THAN 60/60/60 WHEN TESTED FROM THE OUTSIDE (NO PROTECTION REQUIRED FOR THE WALL AT RIGHT ANGLES OR MORE TO THE BOUNDARY) AS PER NCC 3.7

REFER TO ENGINEER'S DRAWINGS FOR BRICKWORK EXPANSION

RECESS ALL EXTERIOR DOOR TRACKS/SILLS

FINISHED RL'S TO BE CONFIRMED ONSITE.

NOTED OTHERWISE.

SELECTED ALUMINUM SLATS
SELECTED BRICKWORK

TOP OF INTERIOR FLOOR FINISHES TO BE FLUSH UNLESS


THRESHOLD DETAIL TO BE CO-ORDINATED WITH WINDOW & DOOR MANUFACTURERS DETAILS TO MAINTAIN


STRUCTURAL RL'S & STEP-DOWNS SHOWN UNLESS NOTED

ALL STEP-DOWNS & REBATES TO BE CONFIRMED ONSITE.


FLOOR FINISHES MUST BE AS/ISO9239
WALL AND CEILING FINISHES MUST MEET A21530.4-2014
PROPOSED DUCTED AIR CONDITIONING SYSTEM TO MEET
AS4254



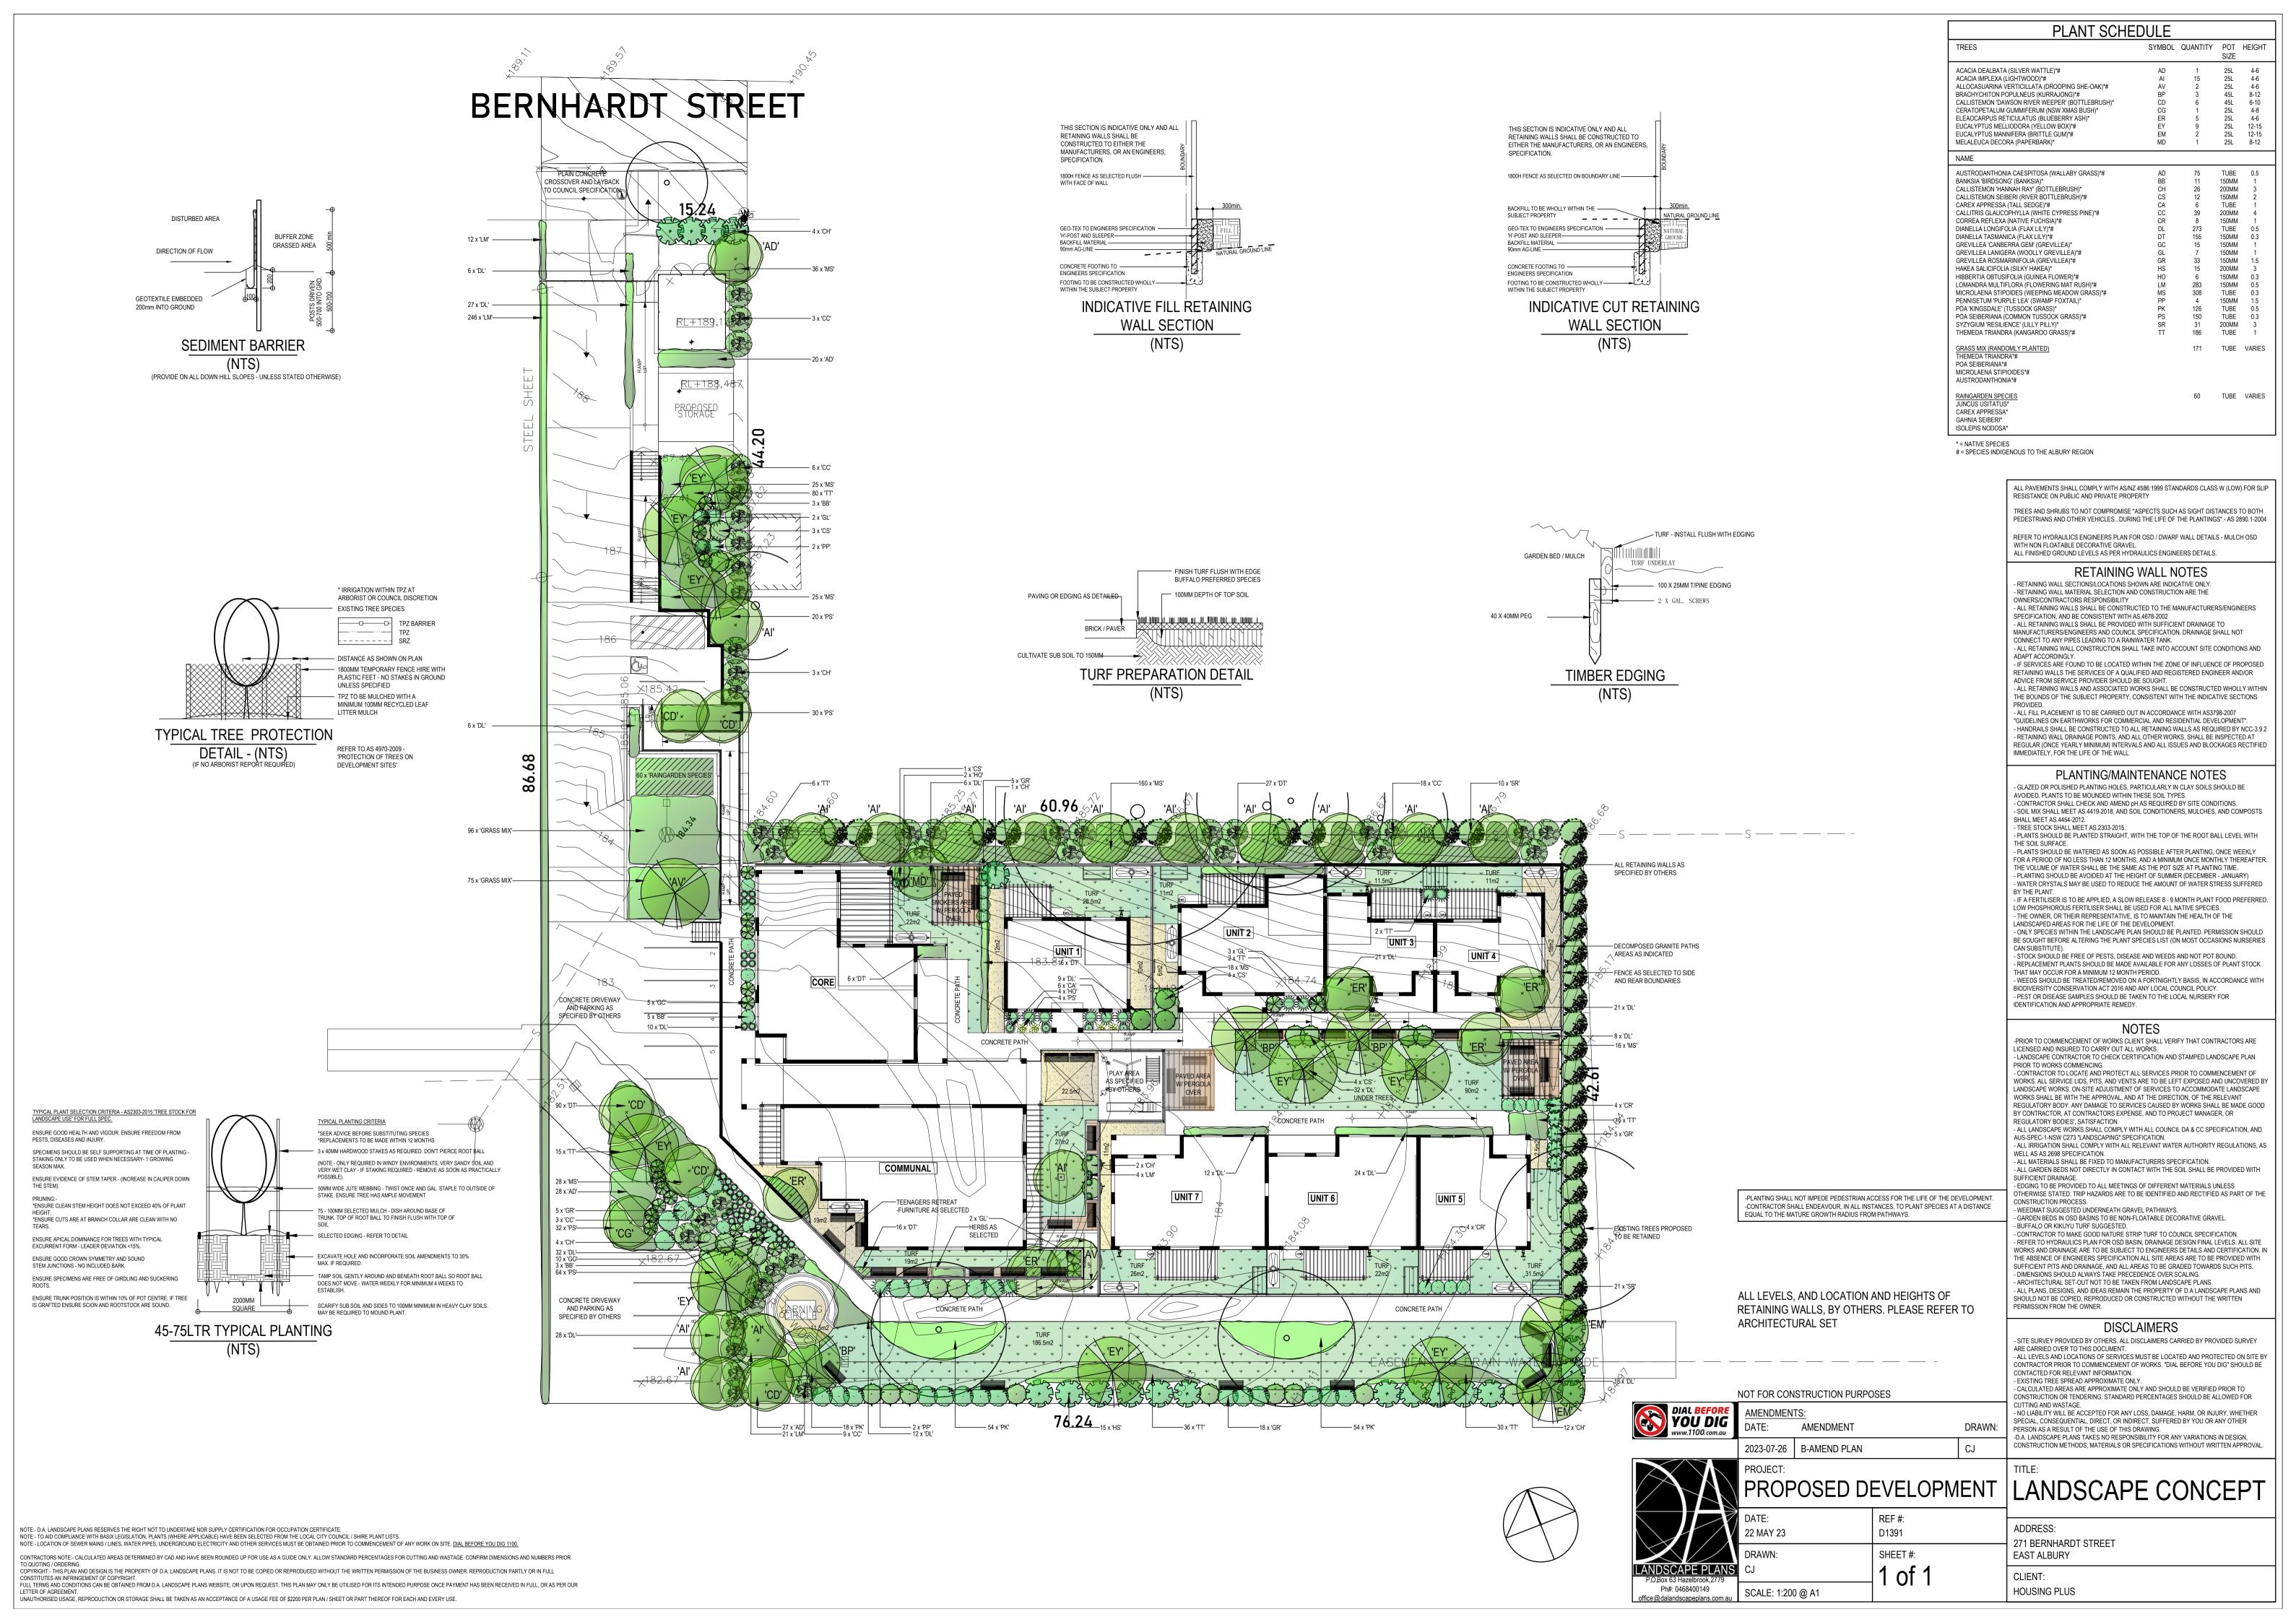


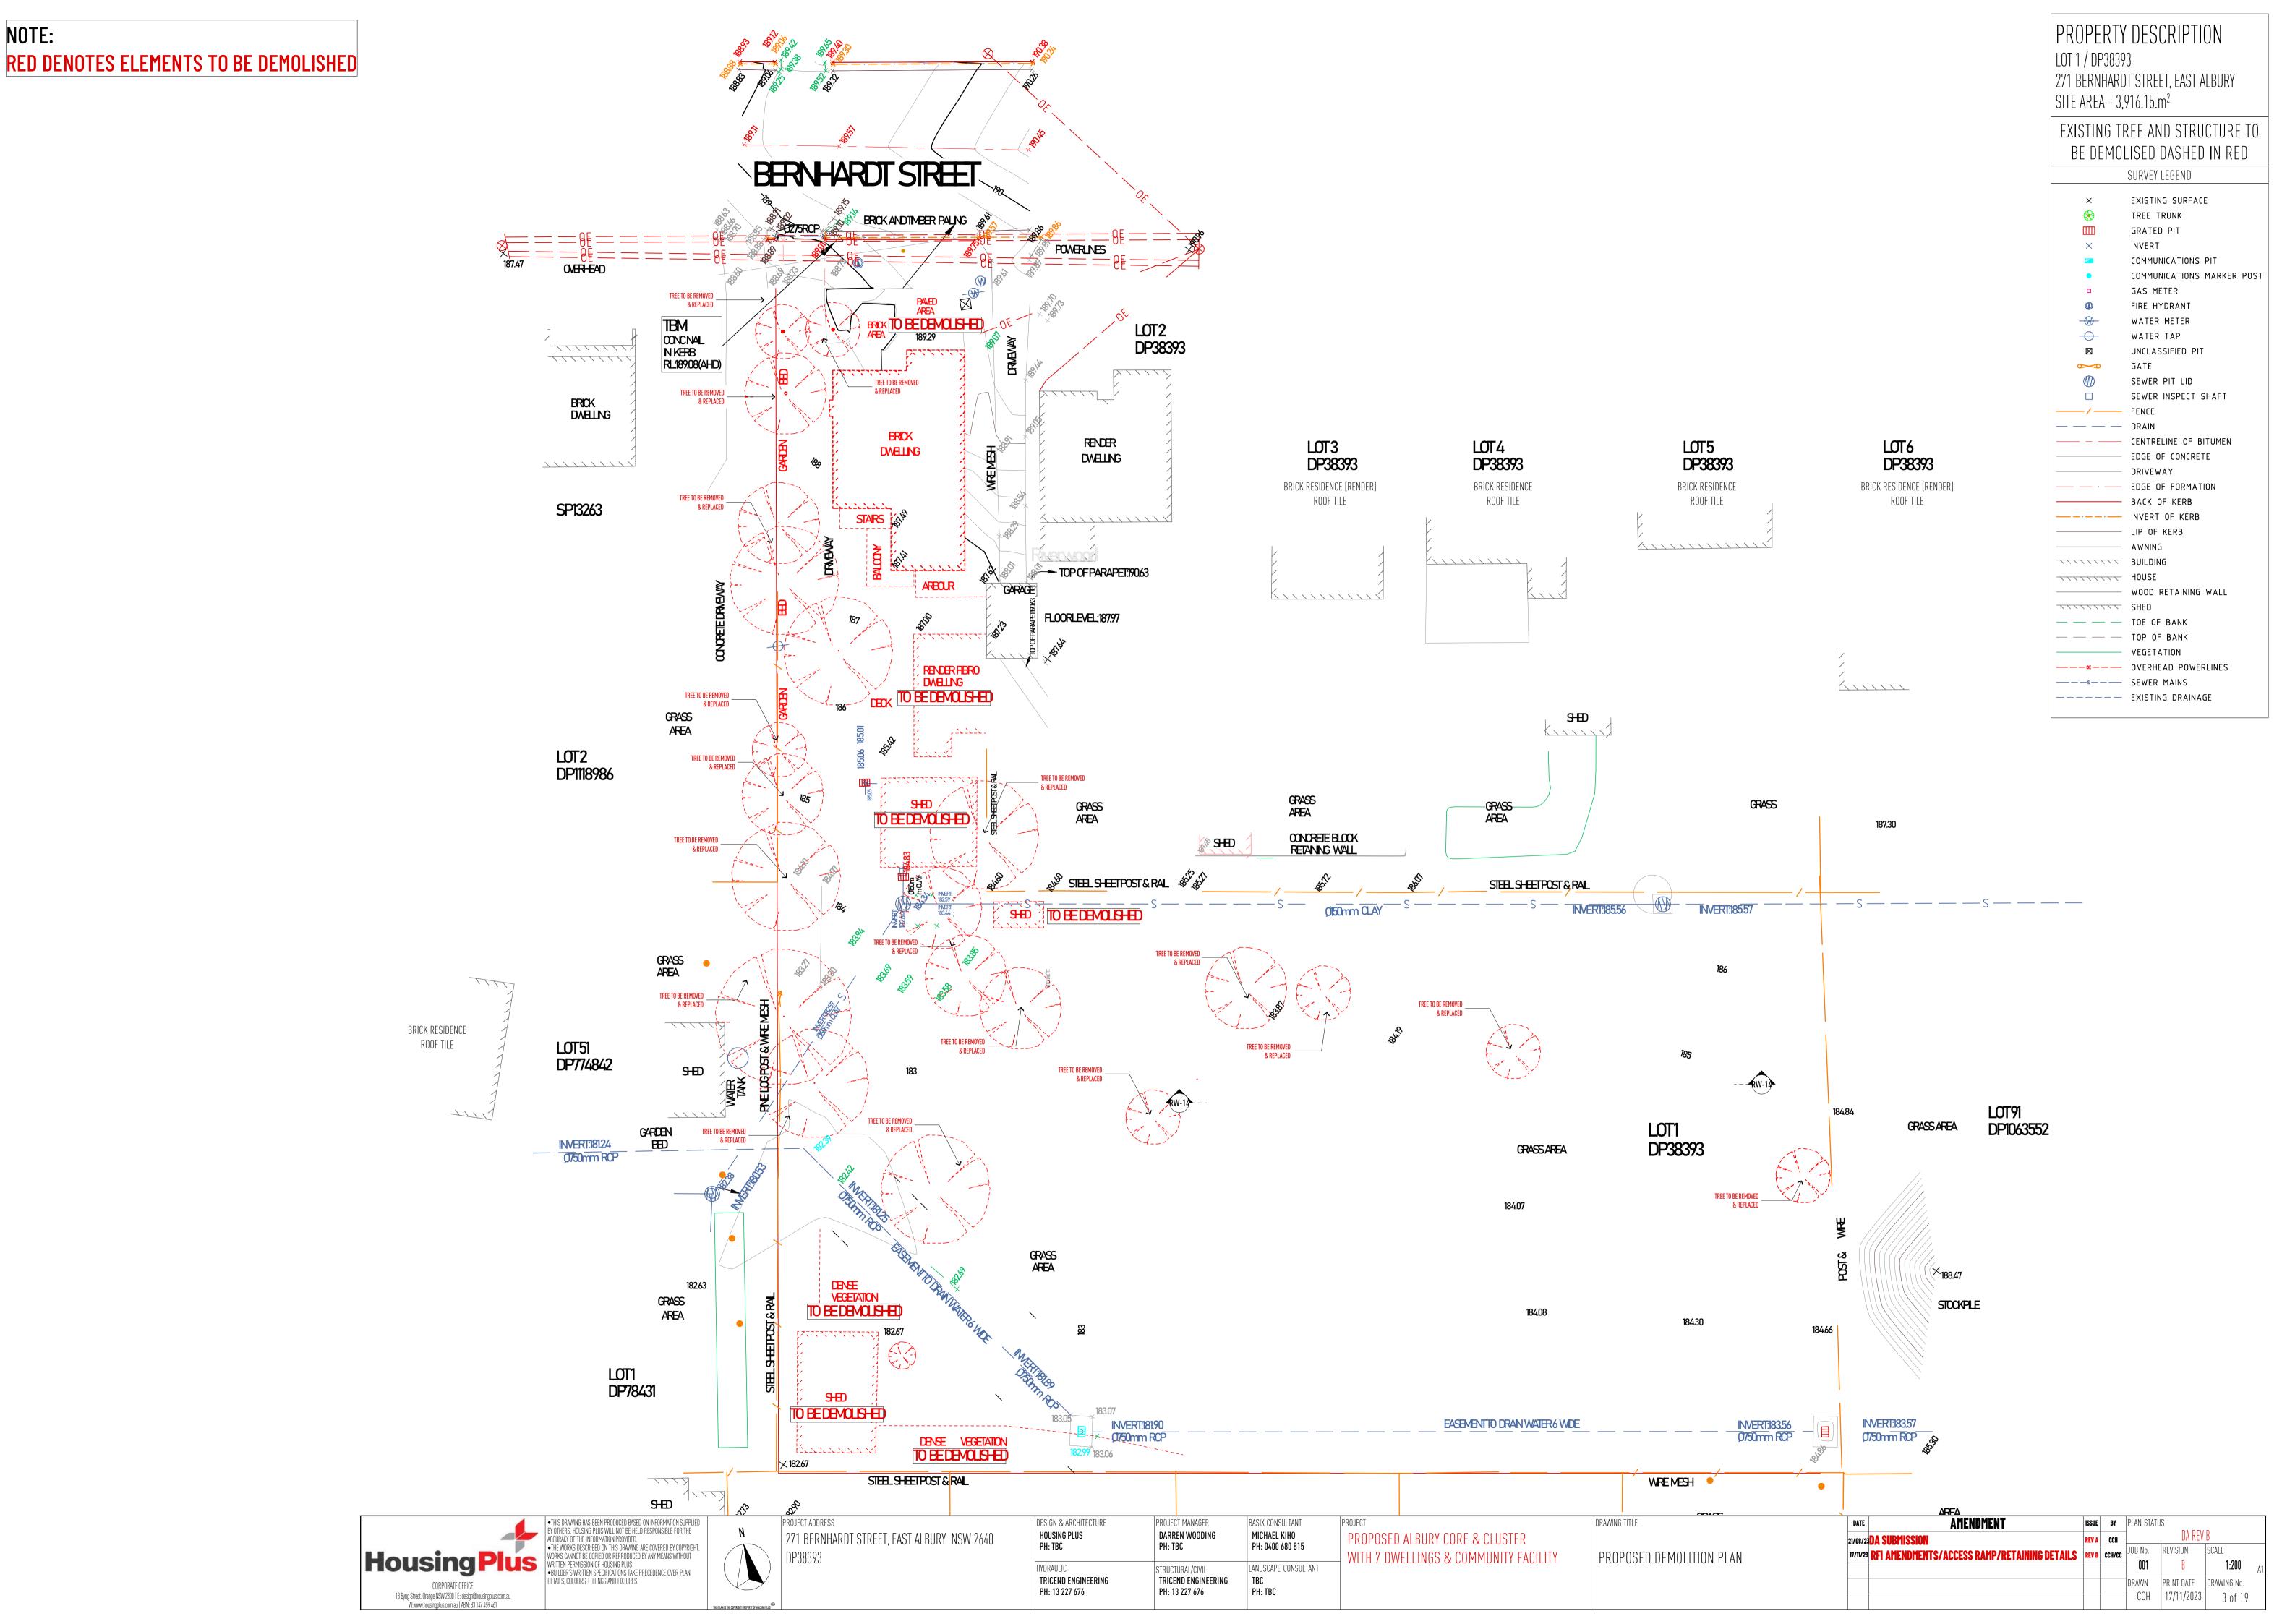

NOTE:

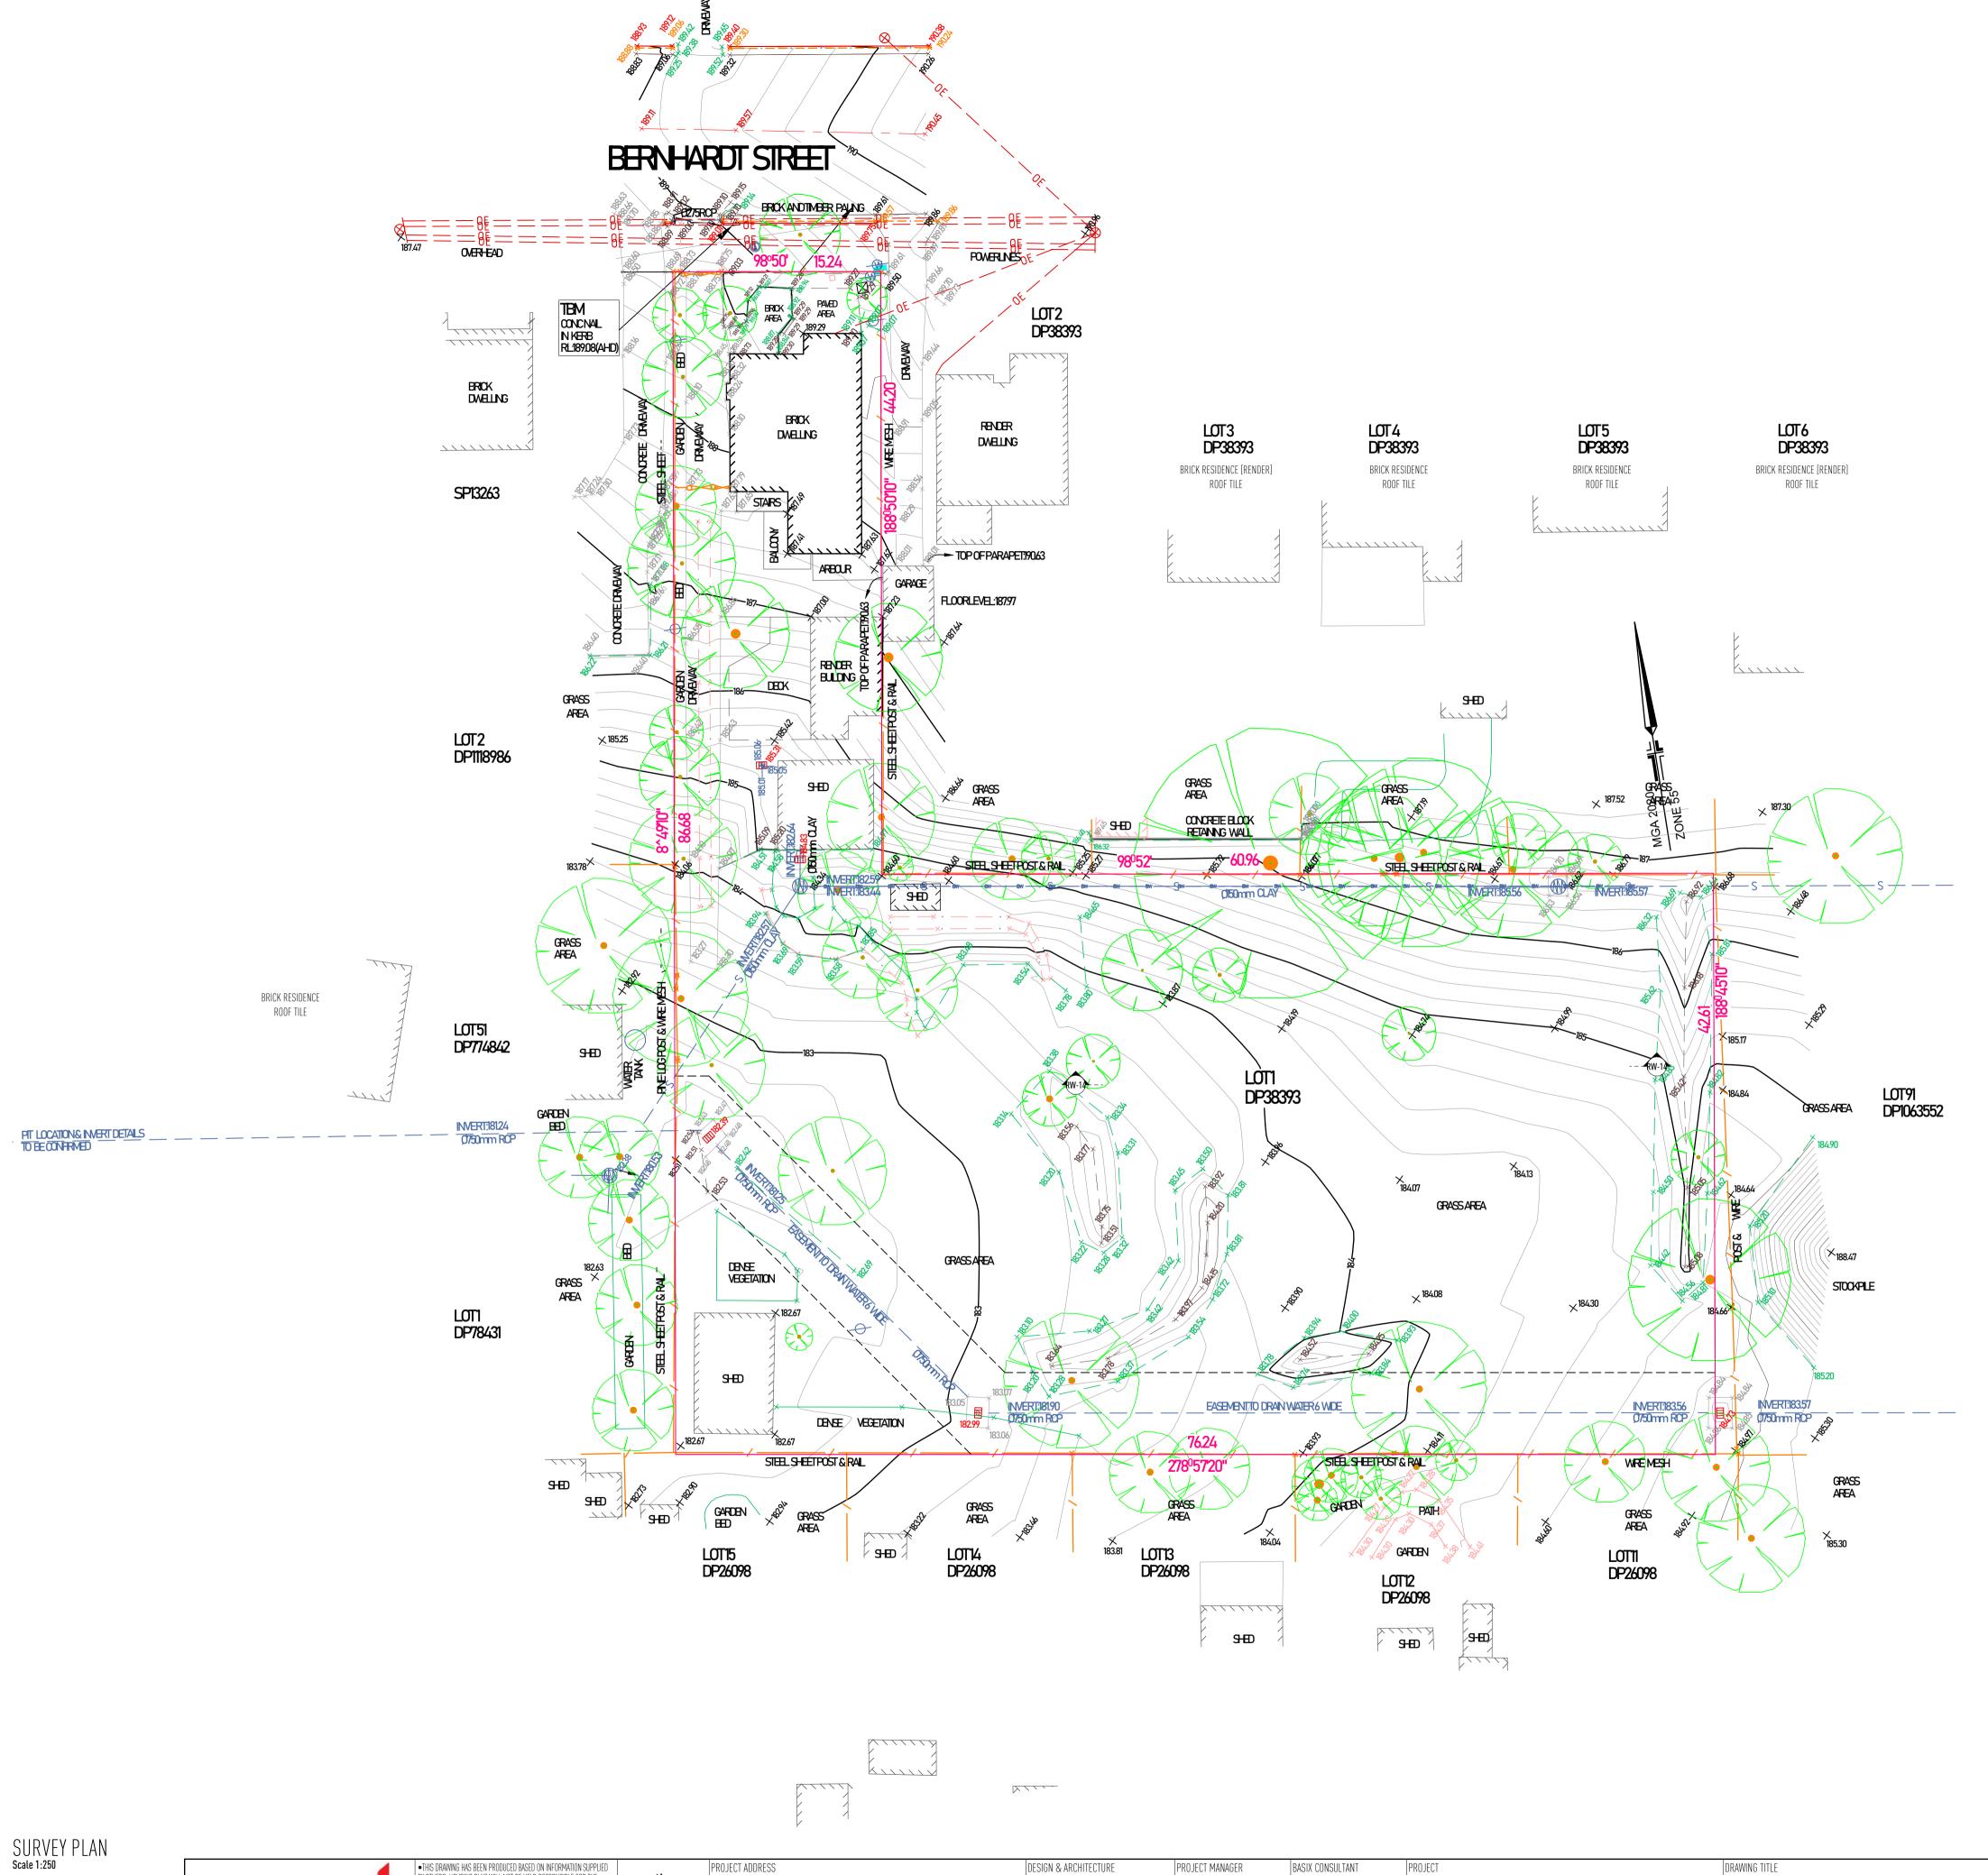

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ACCURACY OF THE INFORMATION PROVIDED. •THE WORKS DESCRIBED ON THIS DRAWING A	RE COVERED BY COPYRIGHT.	DT STREET, EAST ALBURY NSW 2640 HOUSING PLUS PH: TBC	DARREN WOODING PH: TBC	MICHAEL KIHO PH: 0400 680 815	PROPOSED ALBURY CORE & CLUSTER	OHDAEA	21/08/23DA SUBMISSION	O /ACCECC DAMD /DETAILUING DETAIL C	REV A CCH	B No. REVIS	JON SCALE
Housing Plus WARTEN PERMISSION OF HOUSING PLUS WRITTEN PERMISSION OF HOUSING PLUS	BY ANY MEANS WITHOUT DP38393	HYDRAULIC	STRUCTURAL/CIVIL	LANDSCAPE CONSULTANT	WITH 7 DWELLINGS & COMMUNITY FACILITY	SURVEY	WITH ATTENUTION I	S/ACCESS RAMP/RETAINING DETAILS	VEA B CCH/CC	001	B 1:250
CORPORATE OFFICE DETAILS, COLOURS, FITTINGS AND FIXTURES.	NECEDENCE OVER FLANV	TRICEND ENGINEERING	TRICEND ENGINEERING	TBC					DR	AWN PRINT	DATE DRAWING No.
13 Byng Street, Orange NSW 2800 E: designföhousingplus.com.au W: www.housingplus.com.au ABN: 83 147 459 461	THE R ME IS THE CONSIDERAL REPORTED TO ADMINISTRAT AN INC.	PH: 13 227 676	PH: 13 227 676	PH: TBC						CCH 17/1	1/2023 2 of 19

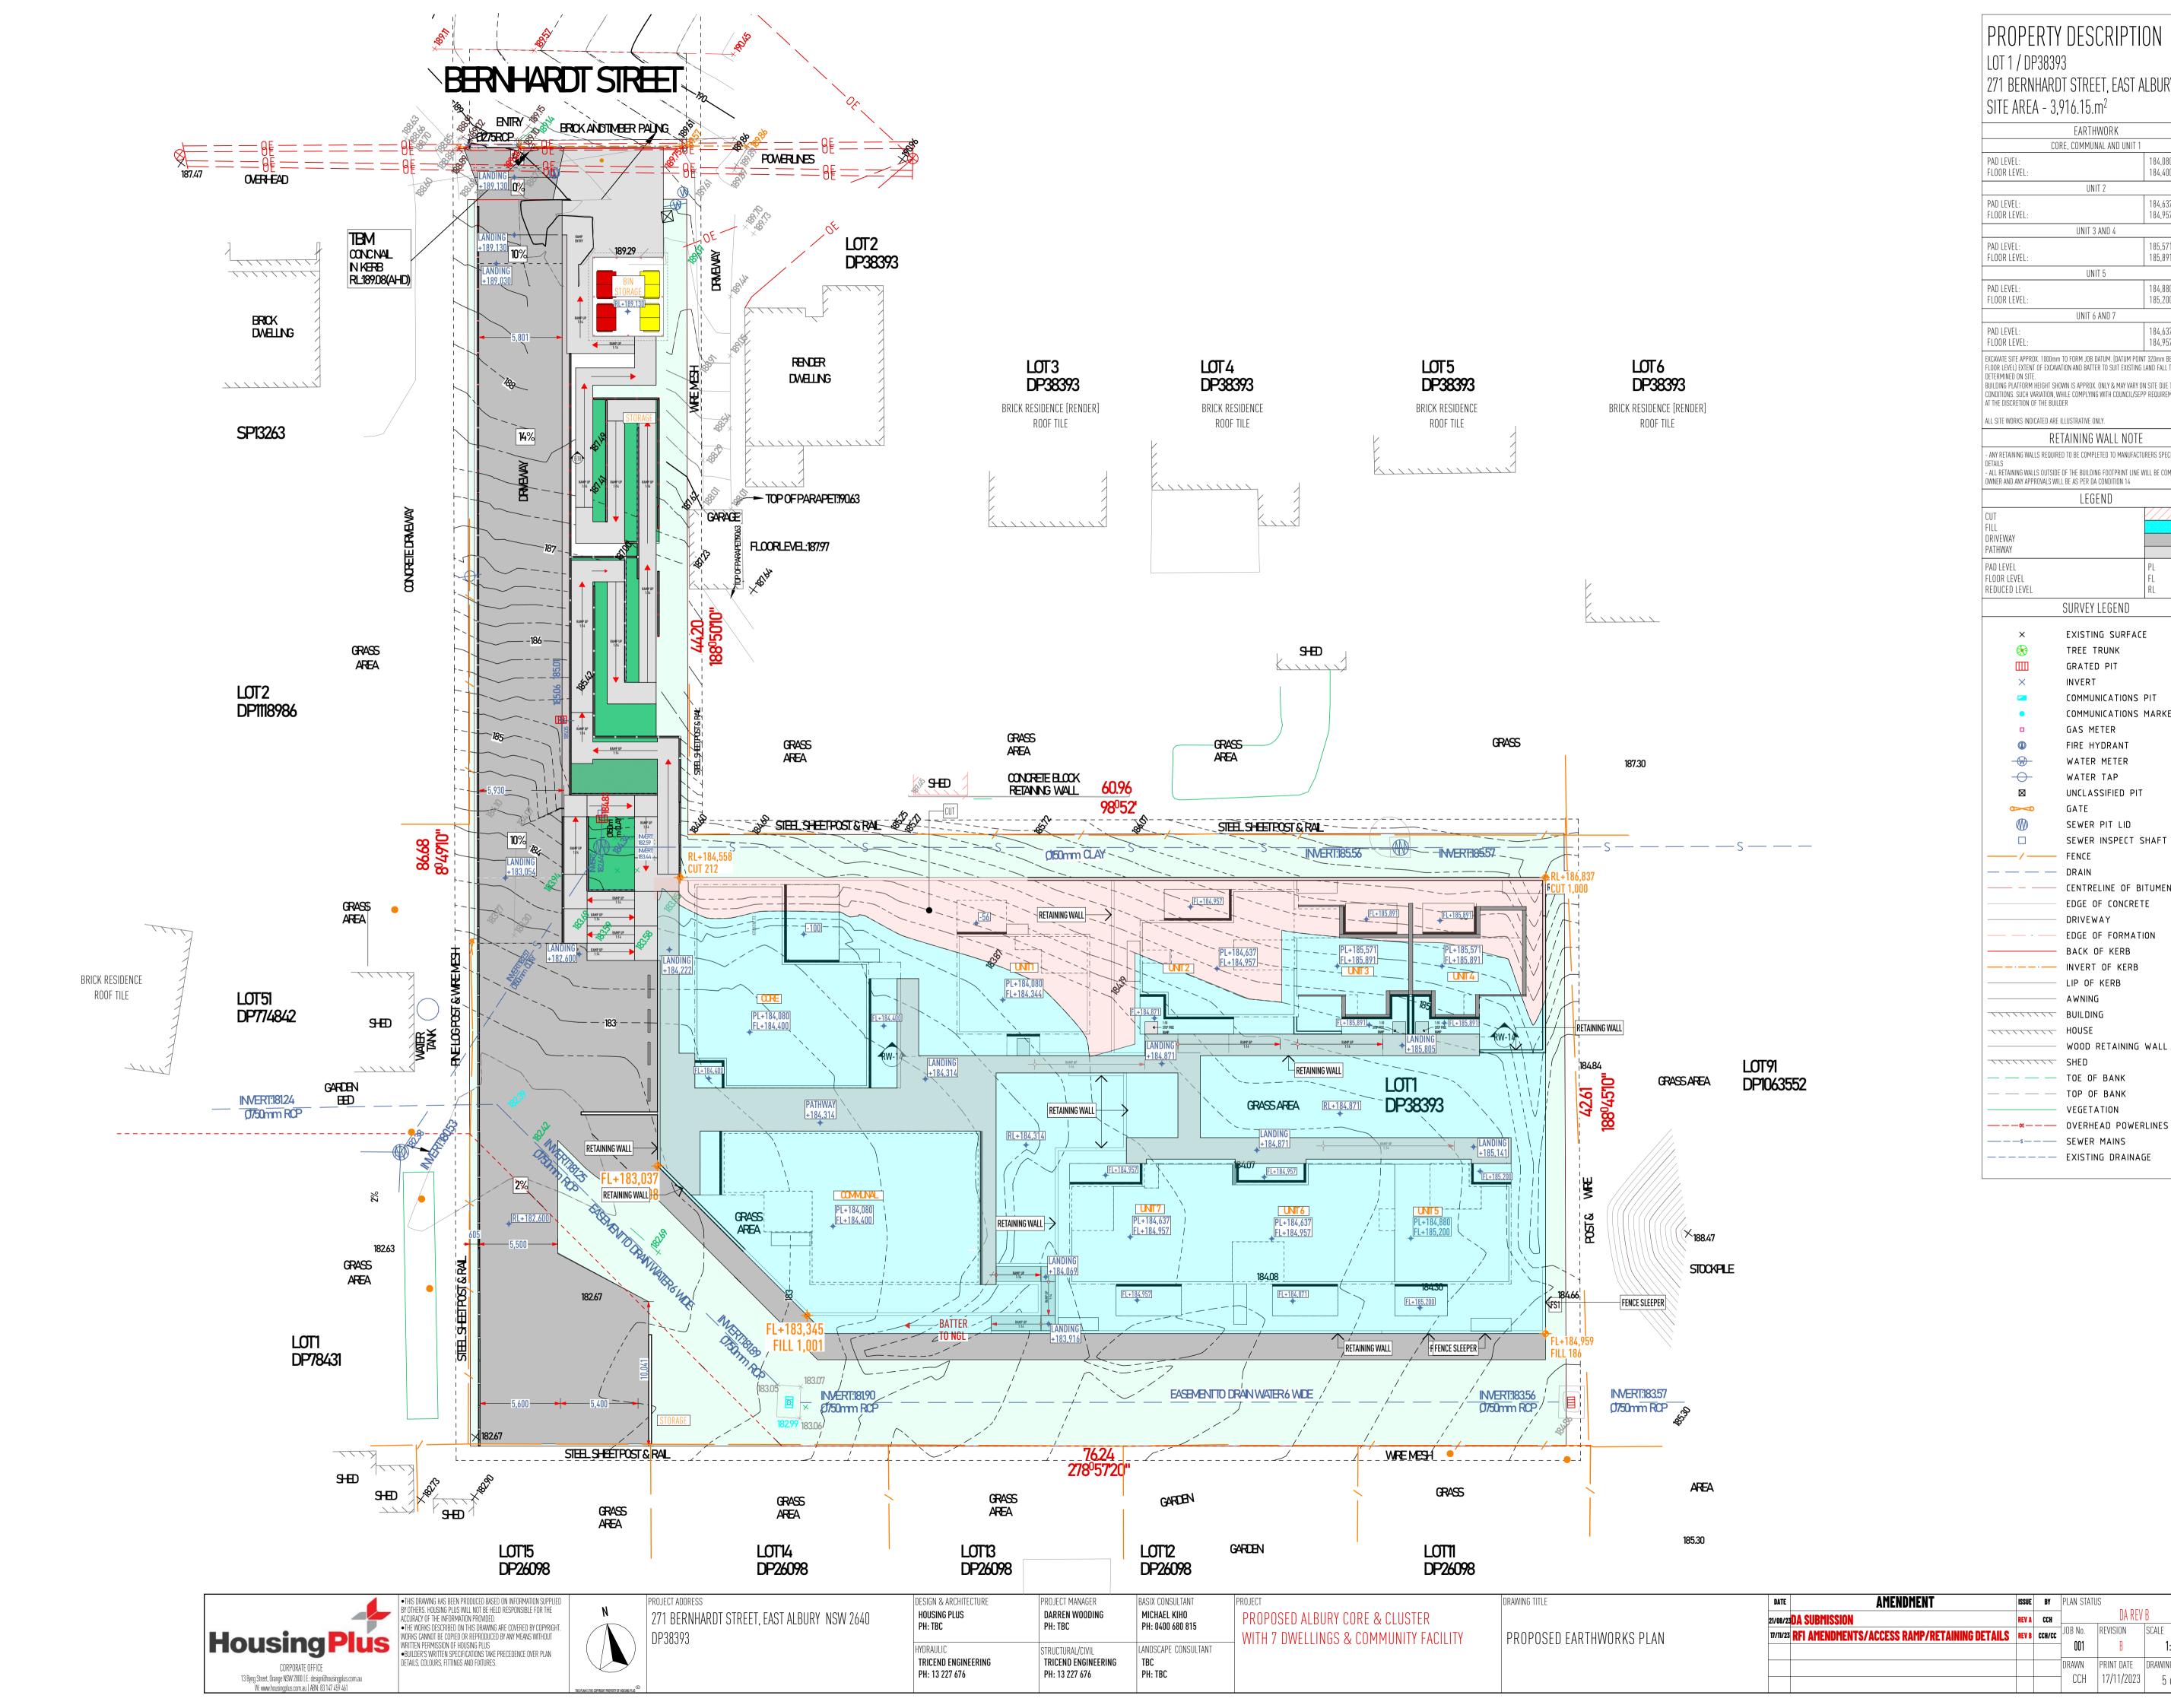

PROPERTY DESCRIPTION LOT 1 / DP38393 271 BERNHARDT STREET, EAST ALBURY | SITE AREA - 3,916.15.m² EARTHWORK CORE, COMMUNAL AND UNIT 1 FLOOR LEVEL: 184,400 UNIT 2 PAD LEVEL: 184,637 FLOOR LEVEL: 184,957 UNIT 3 AND 4 185,571 185,891 FLOOR LEVEL: PAD LEVEL: 184,880 FLOOR LEVEL: 185,200 UNIT 6 AND 7 PAD LEVEL: FLOOR LEVEL: 184,957 EXCAVATE SITE APPROX. 1000mm TO FORM JOB DATUM. (DATUM POINT 320mm BELOW FINISHED FLOOR LEVEL) EXTENT OF EXCAVATION AND BATTER TO SUIT EXISTING LAND FALL TO BE DETERMINED ON SITE. BUILDING PLATFORM HEIGHT SHOWN IS APPROX. ONLY & MAY VARY ON SITE DUE TO SITE CONDITIONS. SUCH VARIATION, WHILE COMPLYING WITH COUNCIL/SEPP REQUIREMENTS REMAIN AT THE DISCRETION OF THE BUILDER ALL SITE WORKS INDICATED ARE ILLUSTRATIVE ONLY. RETAINING WALL NOTE - ANY RETAINING WALLS REQUIRED TO BE COMPLETED TO MANUFACTURERS SPECIFICATIONS AND - ALL RETAINING WALLS OUTSIDE OF THE BUILDING FOOTPRINT LINE WILL BE COMPLETED BY OWNER AND ANY APPROVALS WILL BE AS PER DA CONDITION 14 LEGEND PATHWAY PAD LEVEL FLOOR LEVEL REDUCED LEVEL SURVEY LEGEND EXISTING SURFACE TREE TRUNK GRATED PIT INVERT COMMUNICATIONS PIT COMMUNICATIONS MARKER POST GAS METER FIRE HYDRANT WATER METER WATER TAP UNCLASSIFIED PIT GATE SEWER PIT LID SEWER INSPECT SHAFT FENCE CENTRELINE OF BITUMEN EDGE OF CONCRETE DRIVEWAY EDGE OF FORMATION BACK OF KERB — — · — · — INVERT OF KERB AWNING BUILDING HOUSE WOOD RETAINING WALL — — — TOE OF BANK

— — — TOP OF BANK

————s——— SEWER MAINS


ISSUE BY PLAN STATUS


DRAWN PRINT DATE DRAWING No.

CCH | 17/11/2023 | 5 of 19

————— EXISTING DRAINAGE

VEGETATION — — — OVERHEAD POWERLINES

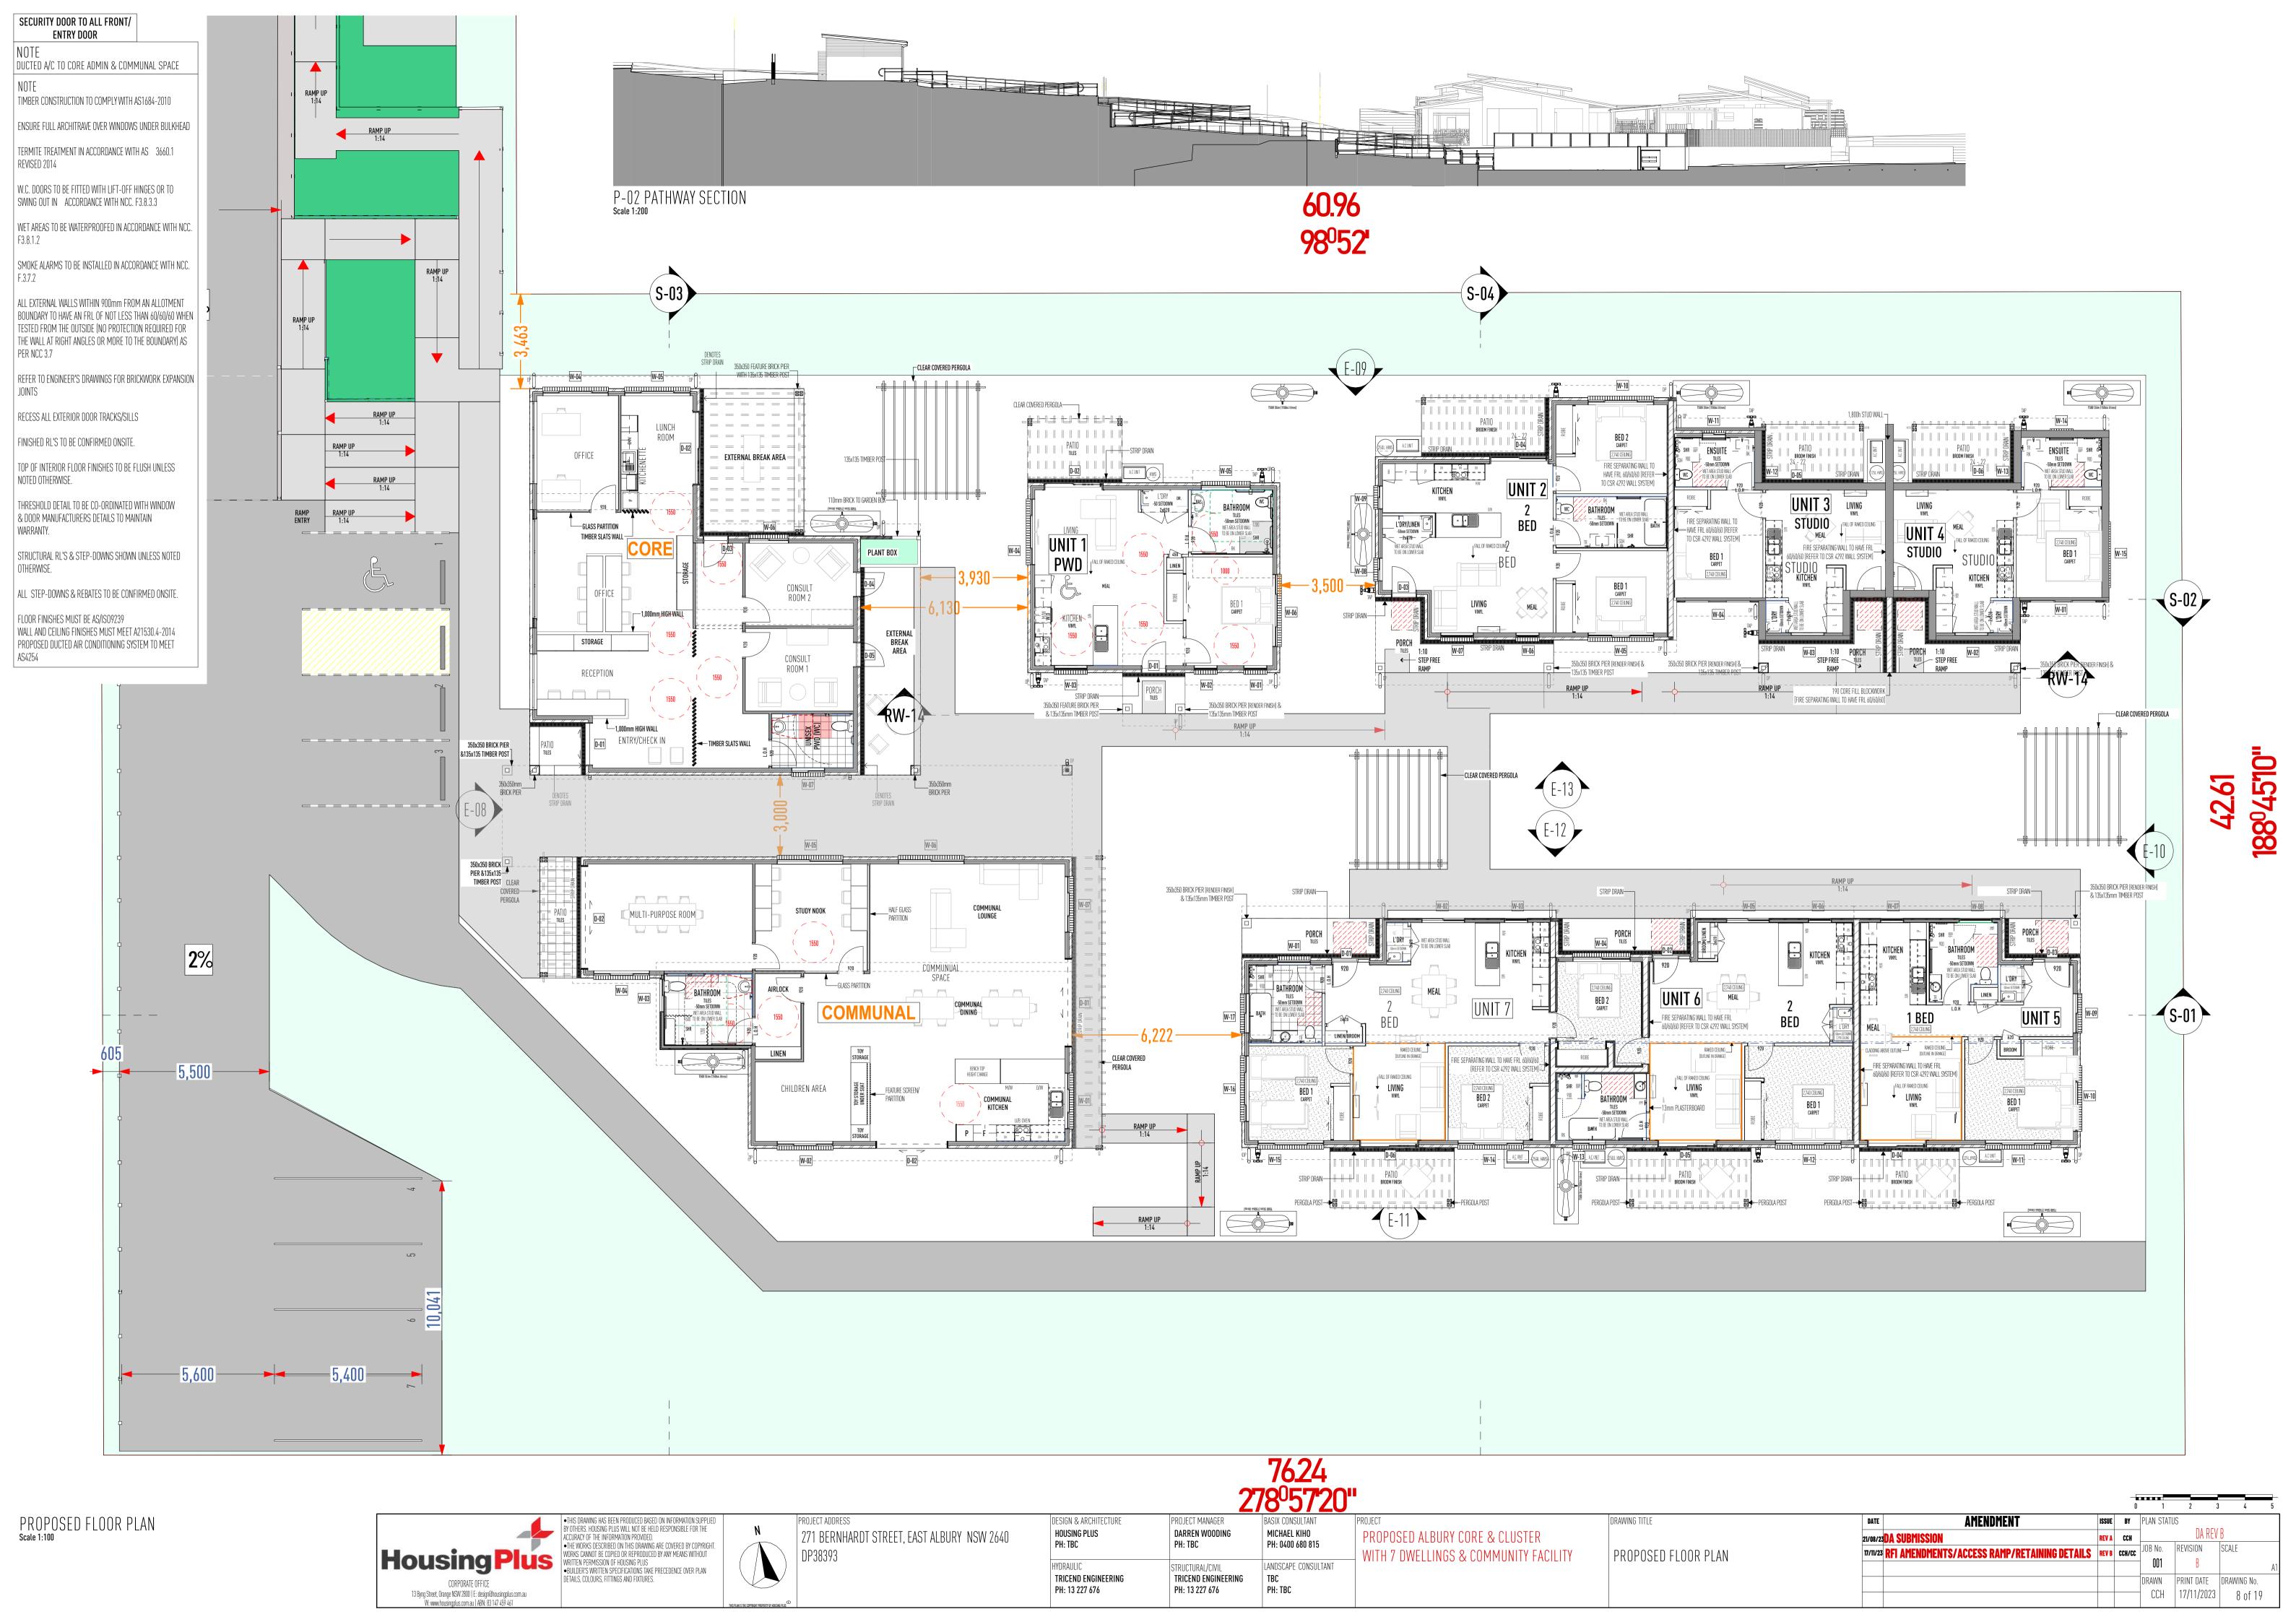

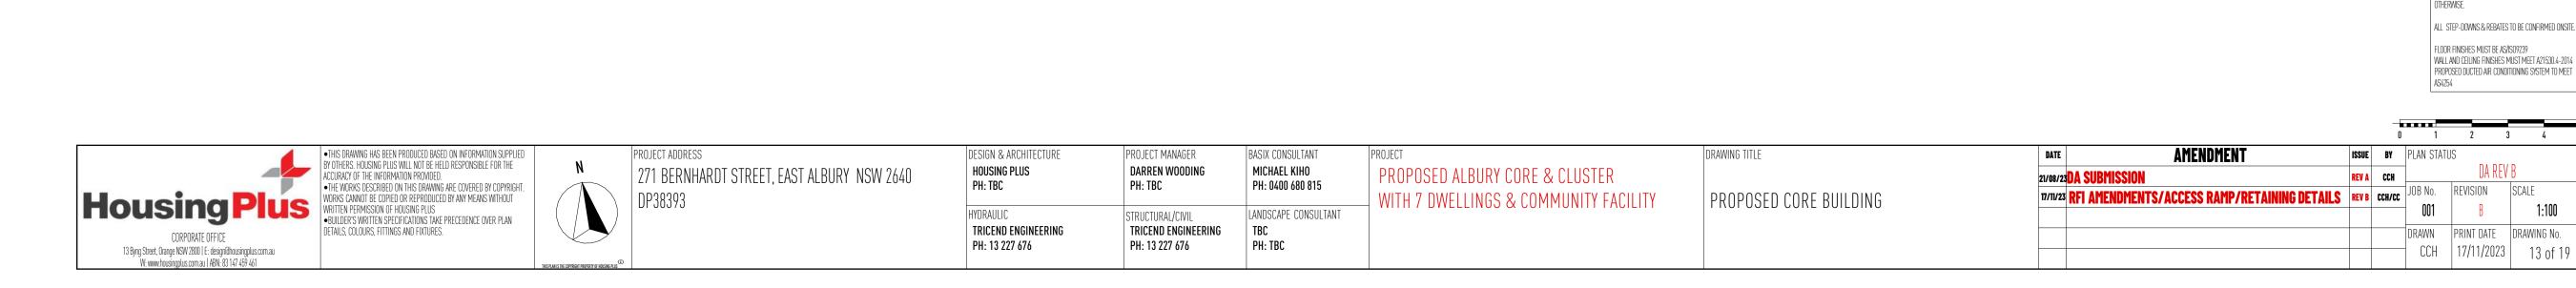


920×2,400

OBSCURE GLAZING

920×2,400

OBSCURE GLAZING

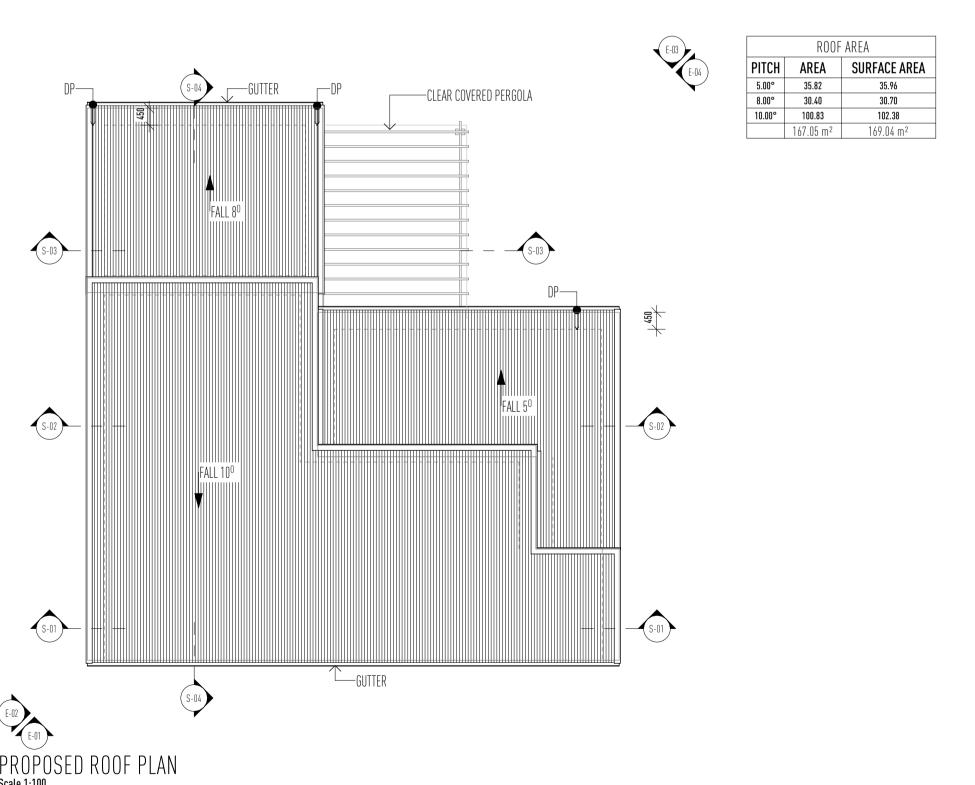

14,070 OVERALL

14,070 OVERALL

LUNCH ROOM

L+184,400

ENTRY/CHECK IN

—GLASS PARTITION

TIMBER SLATS WALL —

OFFICE

STORAGE

RECEPTION

1,920 1,570 470 0R 1,920 250 PATIO 250

PROPOSED CORE BUILDING PLAN

350x350 FEATURE BRICK PIER WITH 135x135 TIMBER POST

EXTERNAL BREAK AREA

CONSULT ROOM 2

CONSULT ROOM 1

135x135 TIMBER POST-

EXTERNAL BREAK AREA

350x350mm BRICK PIER

CORE AREA CALCULATION

CORE BUILDING

PATI0


37.37


133.59

3.92

174.88 m²

110mm BRICK TO GARDEN BOX—

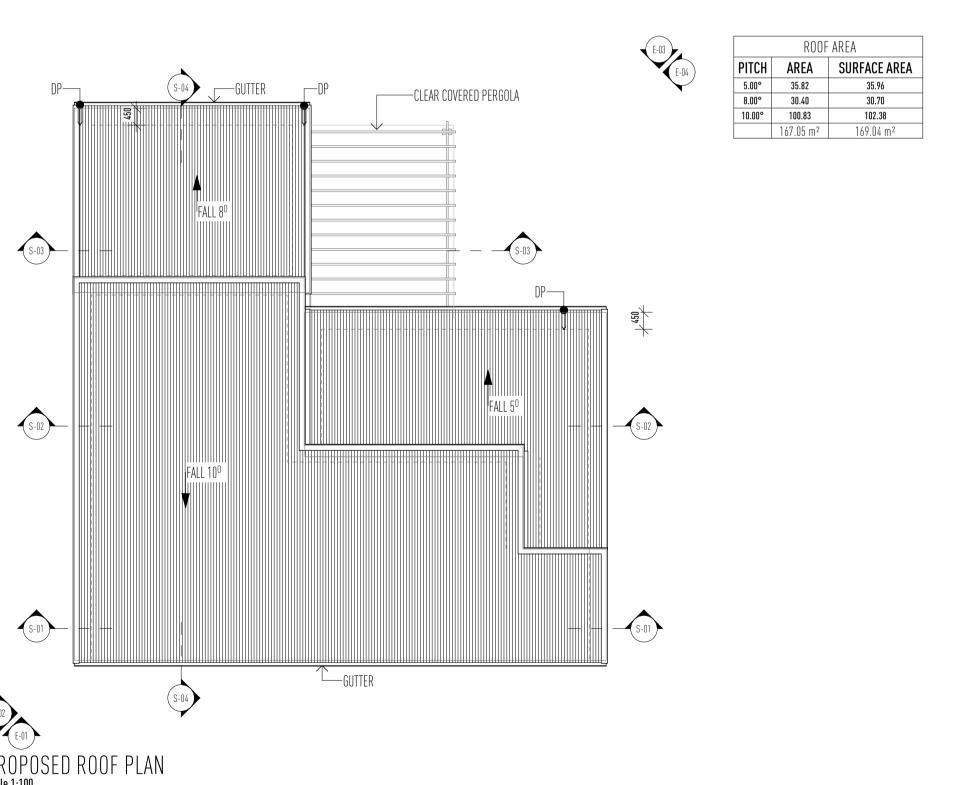

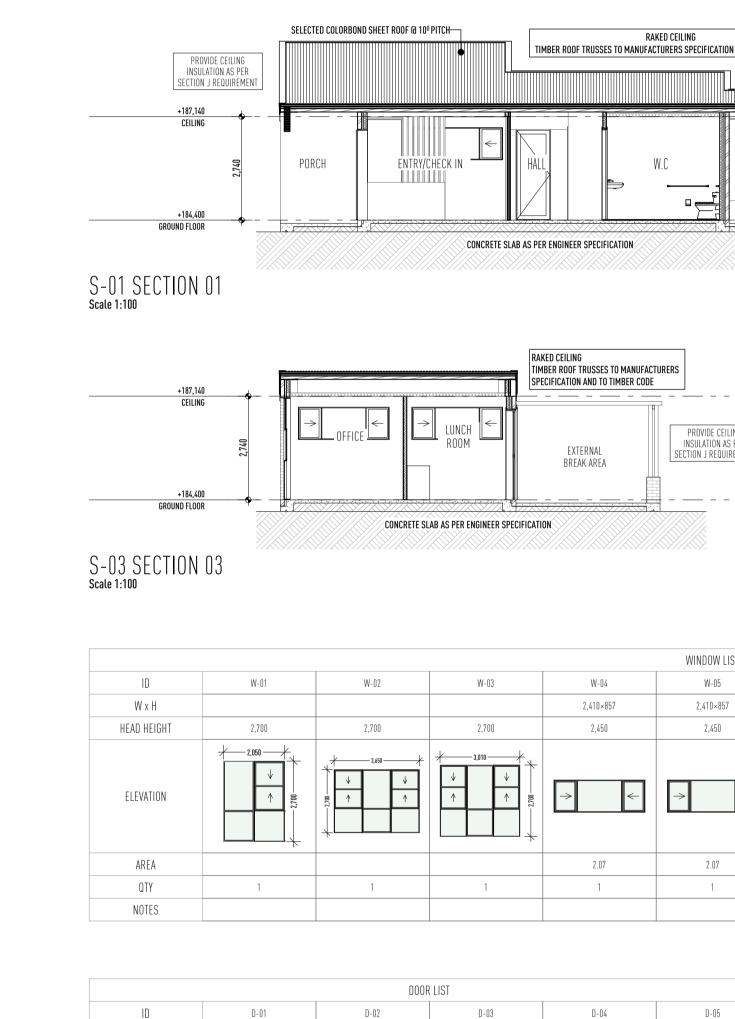

2,700×2,400

920×2,400

OBSCURE GLAZING

WxH

ELEVATION

QTY

NOTES

1,570×2,400

RIDGE RL189,113

350x350mm_ BRICK PIER

SELECTED COLORBOND_ SHEET ROOF @ 5º PITCH

TIMBER POST 350x350mm FEATURE BRICK PIER


1 CRS Stepdown to Porch

SELECTED COLORBOND

__350x350mm BRICK PIER

SHEET ROOF @ 10⁰ PITCH

SELECTED BRICKWORK

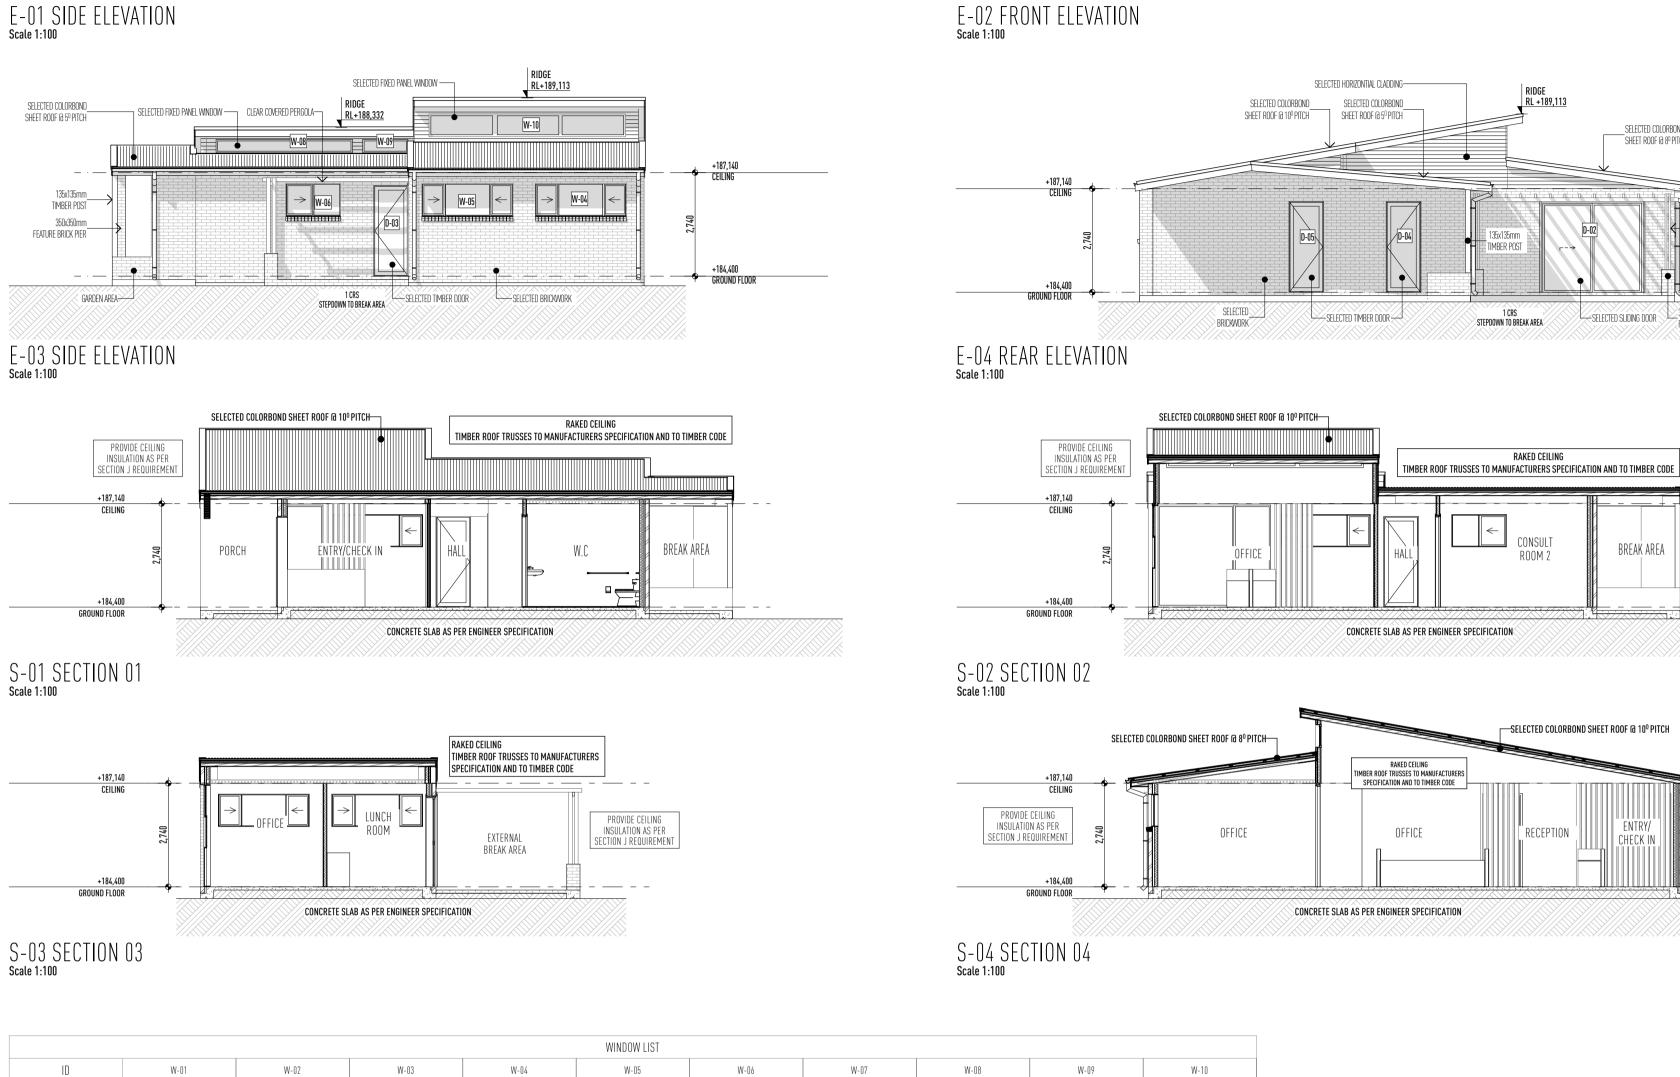

1,450×857

2,450

1.24

1,210×1,029

2,450

1.25

1

OBSCURE GLAZING

3,610×350

875

1.26

1

1,200×350

0.42

5,200×600

1,550

3.12

1

RIDGE RL+189,113

SELECTED HORIZONTIAL CLADDING-

SELECTED COLORBOND

SHEET ROOF @ 8º PITCH

SELECTED ALUMINIUM WINDOW—

SELECTED COLORBOND
SHEET ROOF @ 10º PITCH

STEPDOWN TO PORCH


SHEET ROOF @ 8º PITCH


SELECTED SLIDING DOOR


BREAK AREA

ENTRY/

CHECK IN

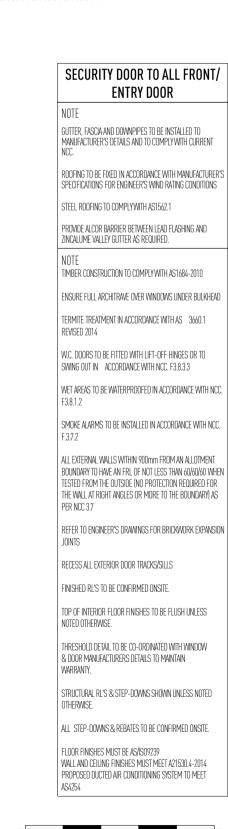

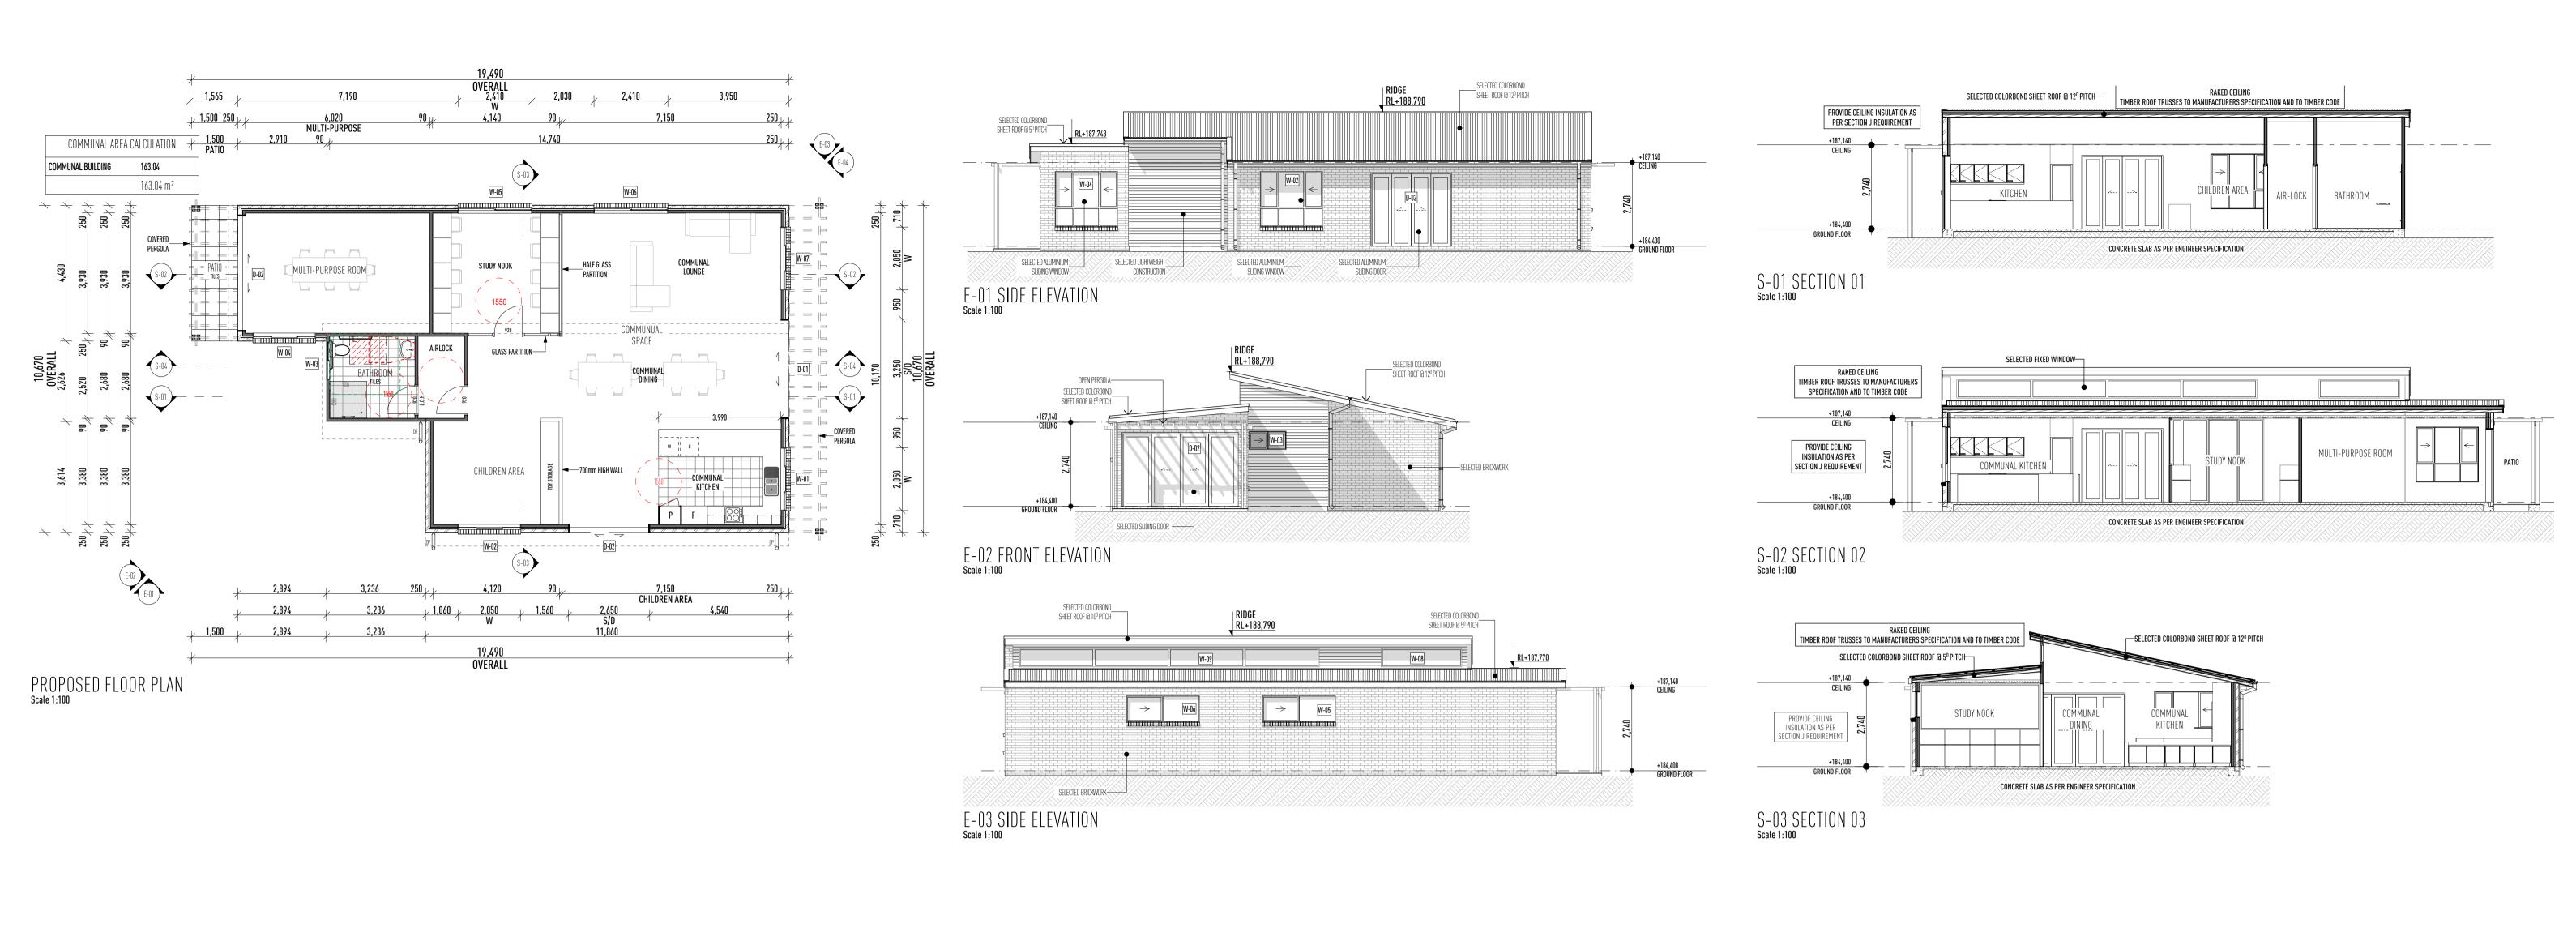

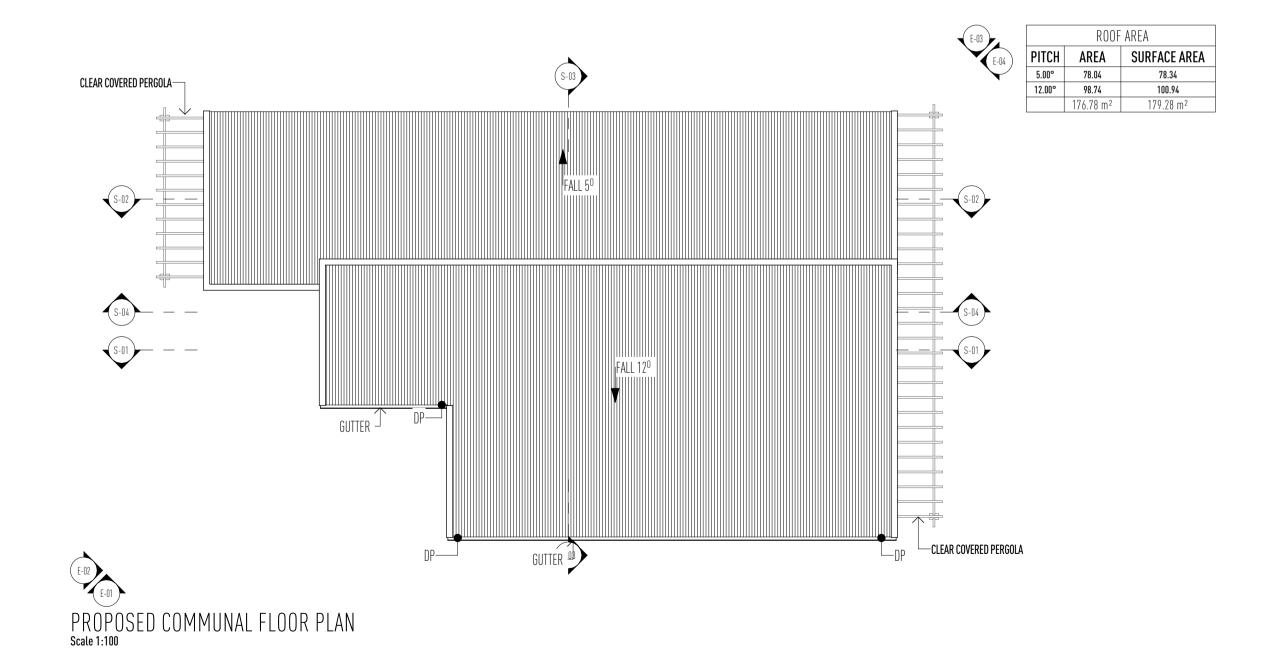



				WIND	OW LIST				
ID	W-01	W-02	W-03	W-04	W-05	W-06	W-07	W-08	W-09
WxH	2,050×1,200	2,050×1,800	1,210×600	2,050×1,800	2,410×857	2,410×857	2,050×1,800	2,600×600	9,800×600
HEAD HEIGHT	2,450	2,450	2,450	2,450	2,450	2,450	2,450	1,250	1,250
ELEVATION	→ ←	→	←	→ <-	\rightarrow	\rightarrow	→ <-		
AREA	2.46	3.69	0.73	3.69	2.07	2.07	3.69	1.56	5.88
QTY	1	1	1	1	1	1	1	1	1
NOTES			OBSCURE GLAZING						

	DOOF	RLIST	
ID	D-01	D-02	D-02
WxH	3,250×2,400	2,650×2,400	3,800×2,400
ELEVATION			
QTY	1	1	1
NOTES			

SECURITY DOOR TO ALL FRONT/ ENTRY DOOR
NOTE
GUTTER, FASCIA AND DOWNPIPES TO BE INSTALLED TO MANUFACTURER'S DETAILS AND TO COMPLY WITH CURRENT NCC.
ROOFING TO BE FIXED IN ACCORDANCE WITH MANUFACTURER'S SPECIFICATIONS FOR ENGINEER'S WIND RATING CONDITIONS
STEEL ROOFING TO COMPLYWITH AS1562.1
PROVIDE ALCOR BARRIER BETWEEN LEAD FLASHING AND ZINCALUME VALLEY GUTTER AS REQUIRED.
NOTE TIMBER CONSTRUCTION TO COMPLYWITH AS1684-2010
ENSURE FULL ARCHITRAVE OVER WINDOWS UNDER BULKHEAD
TERMITE TREATMENT IN ACCORDANCE WITH AS 3660.1 REVISED 2014
W.C. DOORS TO BE FITTED WITH LIFT-OFF HINGES OR TO SWING OUT IN ACCORDANCE WITH NCC. F3.8.3.3
WET AREAS TO BE WATERPROOFED IN ACCORDANCE WITH NCC. F3.8.1.2
SMOKE ALARMS TO BE INSTALLED IN ACCORDANCE WITH NCC. F.3.7.2
ALL EXTERNAL WALLS WITHIN 900mm FROM AN ALLOTMENT BOUNDARY TO HAVE AN FRL OF NOT LESS THAN 60/60/60 WHEN TESTED FROM THE OUTSIDE INO PROTECTION REDUIRED FOR THE WALL AT RIGHT ANGLES OR MORE TO THE BOUNDARY) AS PER NCC 3.7
REFER TO ENGINEER'S DRAWINGS FOR BRICKWORK EXPANSION JOINTS
RECESS ALL EXTERIOR DOOR TRACKS/SILLS
FINISHED RL'S TO BE CONFIRMED ONSITE.
TOP OF INTERIOR FLOOR FINISHES TO BE FLUSH UNLESS NOTED OTHERWISE.
THRESHOLD DETAIL TO BE CO-ORDINATED WITH WINDOW & DOOR MANUFACTURERS DETAILS TO MAINTAIN WARRANTY.
STRUCTURAL RL'S & STEP-DOWNS SHOWN UNLESS NOTED OTHERWISE.
ALL STEP-DOWNS & REBATES TO BE CONFIRMED ONSITE.
FLOOR FINISHES MUST BE AS/ISO9239 WALL AND CEILING FINISHES MUST MEET A21530.4-2014 PROPOSED DUCTED AIR CONDITIONING SYSTEM TO MEET ASA254




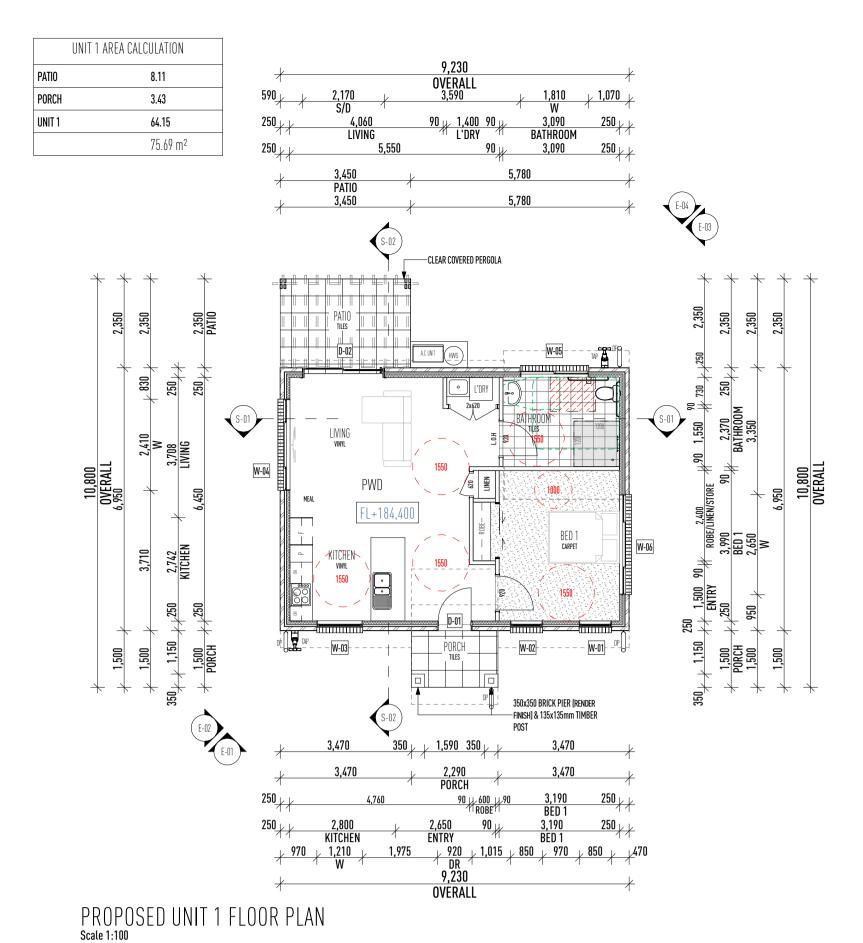


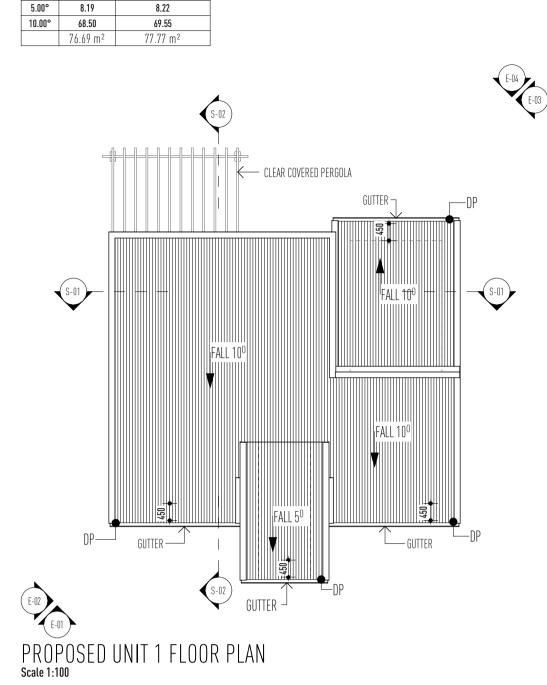


ROOF AREA

PITCH AREA SURFACE AREA

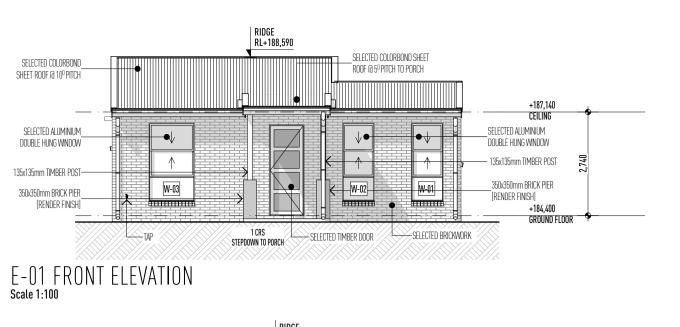

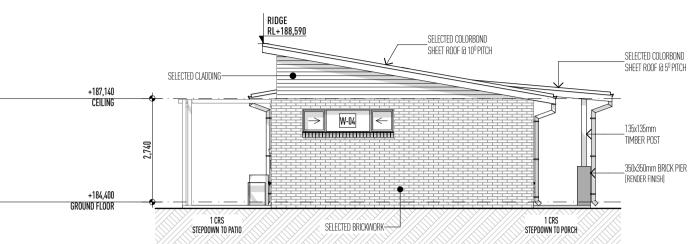

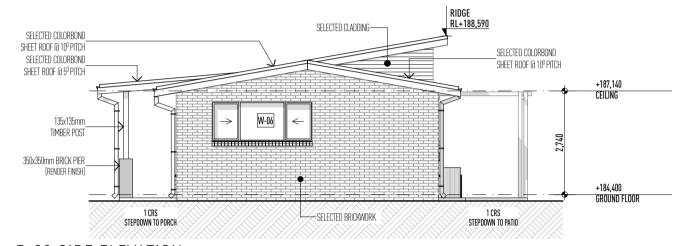


E-02 SIDE ELEVATION Scale 1:100

QTY NOTES



OBSCURE GLASS

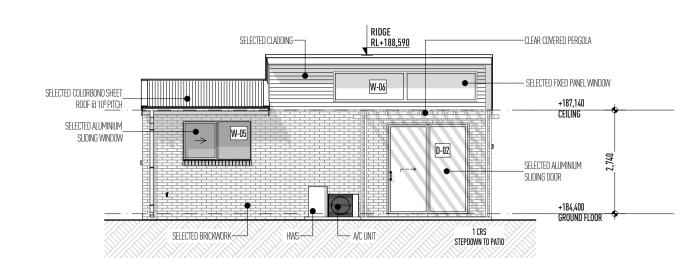

SECURITY DOOR TO ALL FRONT/ ENTRY DOOR

GUTTER, FASCIA AND DOWNPIPES TO BE INSTALLED TO MANUFACTURER'S DETAILS AND TO COMPLY WITH CURRENT

ROOFING TO BE FIXED IN ACCORDANCE WITH MANUFACTURER'S SPECIFICATIONS FOR ENGINEER'S WIND RATING CONDITIONS

PROVIDE ALCOR BARRIER BETWEEN LEAD FLASHING AND

TIMBER CONSTRUCTION TO COMPLY WITH AS1684-2010

ENSURE FULL ARCHITRAVE OVER WINDOWS UNDER BULKHEAD

TERMITE TREATMENT IN ACCORDANCE WITH AS 3660.1

W.C. DOORS TO BE FITTED WITH LIFT-OFF HINGES OR TO SWING OUT IN ACCORDANCE WITH NCC. F3.8.3.3

WET AREAS TO BE WATERPROOFED IN ACCORDANCE WITH NCC.

SMOKE ALARMS TO BE INSTALLED IN ACCORDANCE WITH NCC.

ALL EXTERNAL WALLS WITHIN 900mm FROM AN ALLOTMENT BOUNDARY TO HAVE AN FRL OF NOT LESS THAN 60/60/60 WHEN

TESTED FROM THE OUTSIDE (NO PROTECTION REQUIRED FOR THE WALL AT RIGHT ANGLES OR MORE TO THE BOUNDARY) AS

REFER TO ENGINEER'S DRAWINGS FOR BRICKWORK EXPANSION

RECESS ALL EXTERIOR DOOR TRACKS/SILLS

FINISHED RL'S TO BE CONFIRMED ONSITE.

NOTED OTHERWISE.

TOP OF INTERIOR FLOOR FINISHES TO BE FLUSH UNLESS

THRESHOLD DETAIL TO BE CO-ORDINATED WITH WINDOW & DOOR MANUFACTURERS DETAILS TO MAINTAIN

STRUCTURAL RL'S & STEP-DOWNS SHOWN UNLESS NOTED

ALL STEP-DOWNS & REBATES TO BE CONFIRMED ONSITE.

WALL AND CEILING FINISHES MUST MEET A21530.4-2014 PROPOSED DUCTED AIR CONDITIONING SYSTEM TO MEET

FLOOR FINISHES MUST BE AS/ISO9239


STEEL ROOFING TO COMPLYWITH AS1562.1

ZINCALUME VALLEY GUTTER AS REQUIRED.

E-04 REAR ELEVATION Scale 1:100



S-01 SECTION 01 Scale 1:100

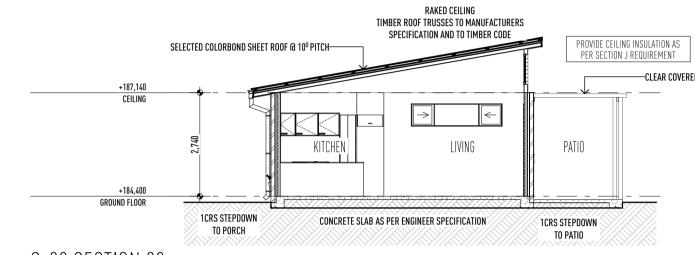

	DOOR LIST	
ID	D-01	D-02
WxH	920×2,400	2,170×2,400
ELEVATION		,
QTY	1	1
NOTES	SECURITY SCREEN REQUIRED	

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PROJECT ADDRESS 271 BERNHARDT STREET, EAST ALBURY NSW 2640 DESIGN & ARCHITECTURE PROJECT MANAGER HOUSING PLUS DARREN WOODING PH: TBC PH: TBC HYDRAULIC STRUCTURAL/CIVIL TRICEND ENGINEERING TRICEND ENGINEERING PH: 13 227 676 PH: 13 227 676

TBC

PH: TBC

BASIX CONSULTANT PROJECT MICHAEL KIHO PROPOSED ALBURY CORE & CLUSTER PH: 0400 680 815 WITH 7 DWELLINGS & COMMUNITY FACILITY LANDSCAPE CONSULTANT

DRAWING TITLE PROPOSED UNIT 1, BIN & STORAGE ROOM BUILDING

AMENDMENT ISSUE BY PLAN STATUS 21/08/23<mark>DA SUBMISSION</mark> T7/11/23 RFI AMENDMENTS/ACCESS RAMP/RETAINING DETAILS REV B CCH/CC JOB No. REVISION SCALE 001 B 1:100 DRAWN PRINT DATE DRAWING No. CCH 17/11/2023 15 of 19

